



DRAWING NAME: \\Bkf-st\vol4\2008\080006_Mission_Rock\ENG\SIP\PLOTTED SHEETS\C5.00 - ROUGH GRADING PLAN.dwg
PLOT DATE: 06-16-19 PLOTTED BY: meyj

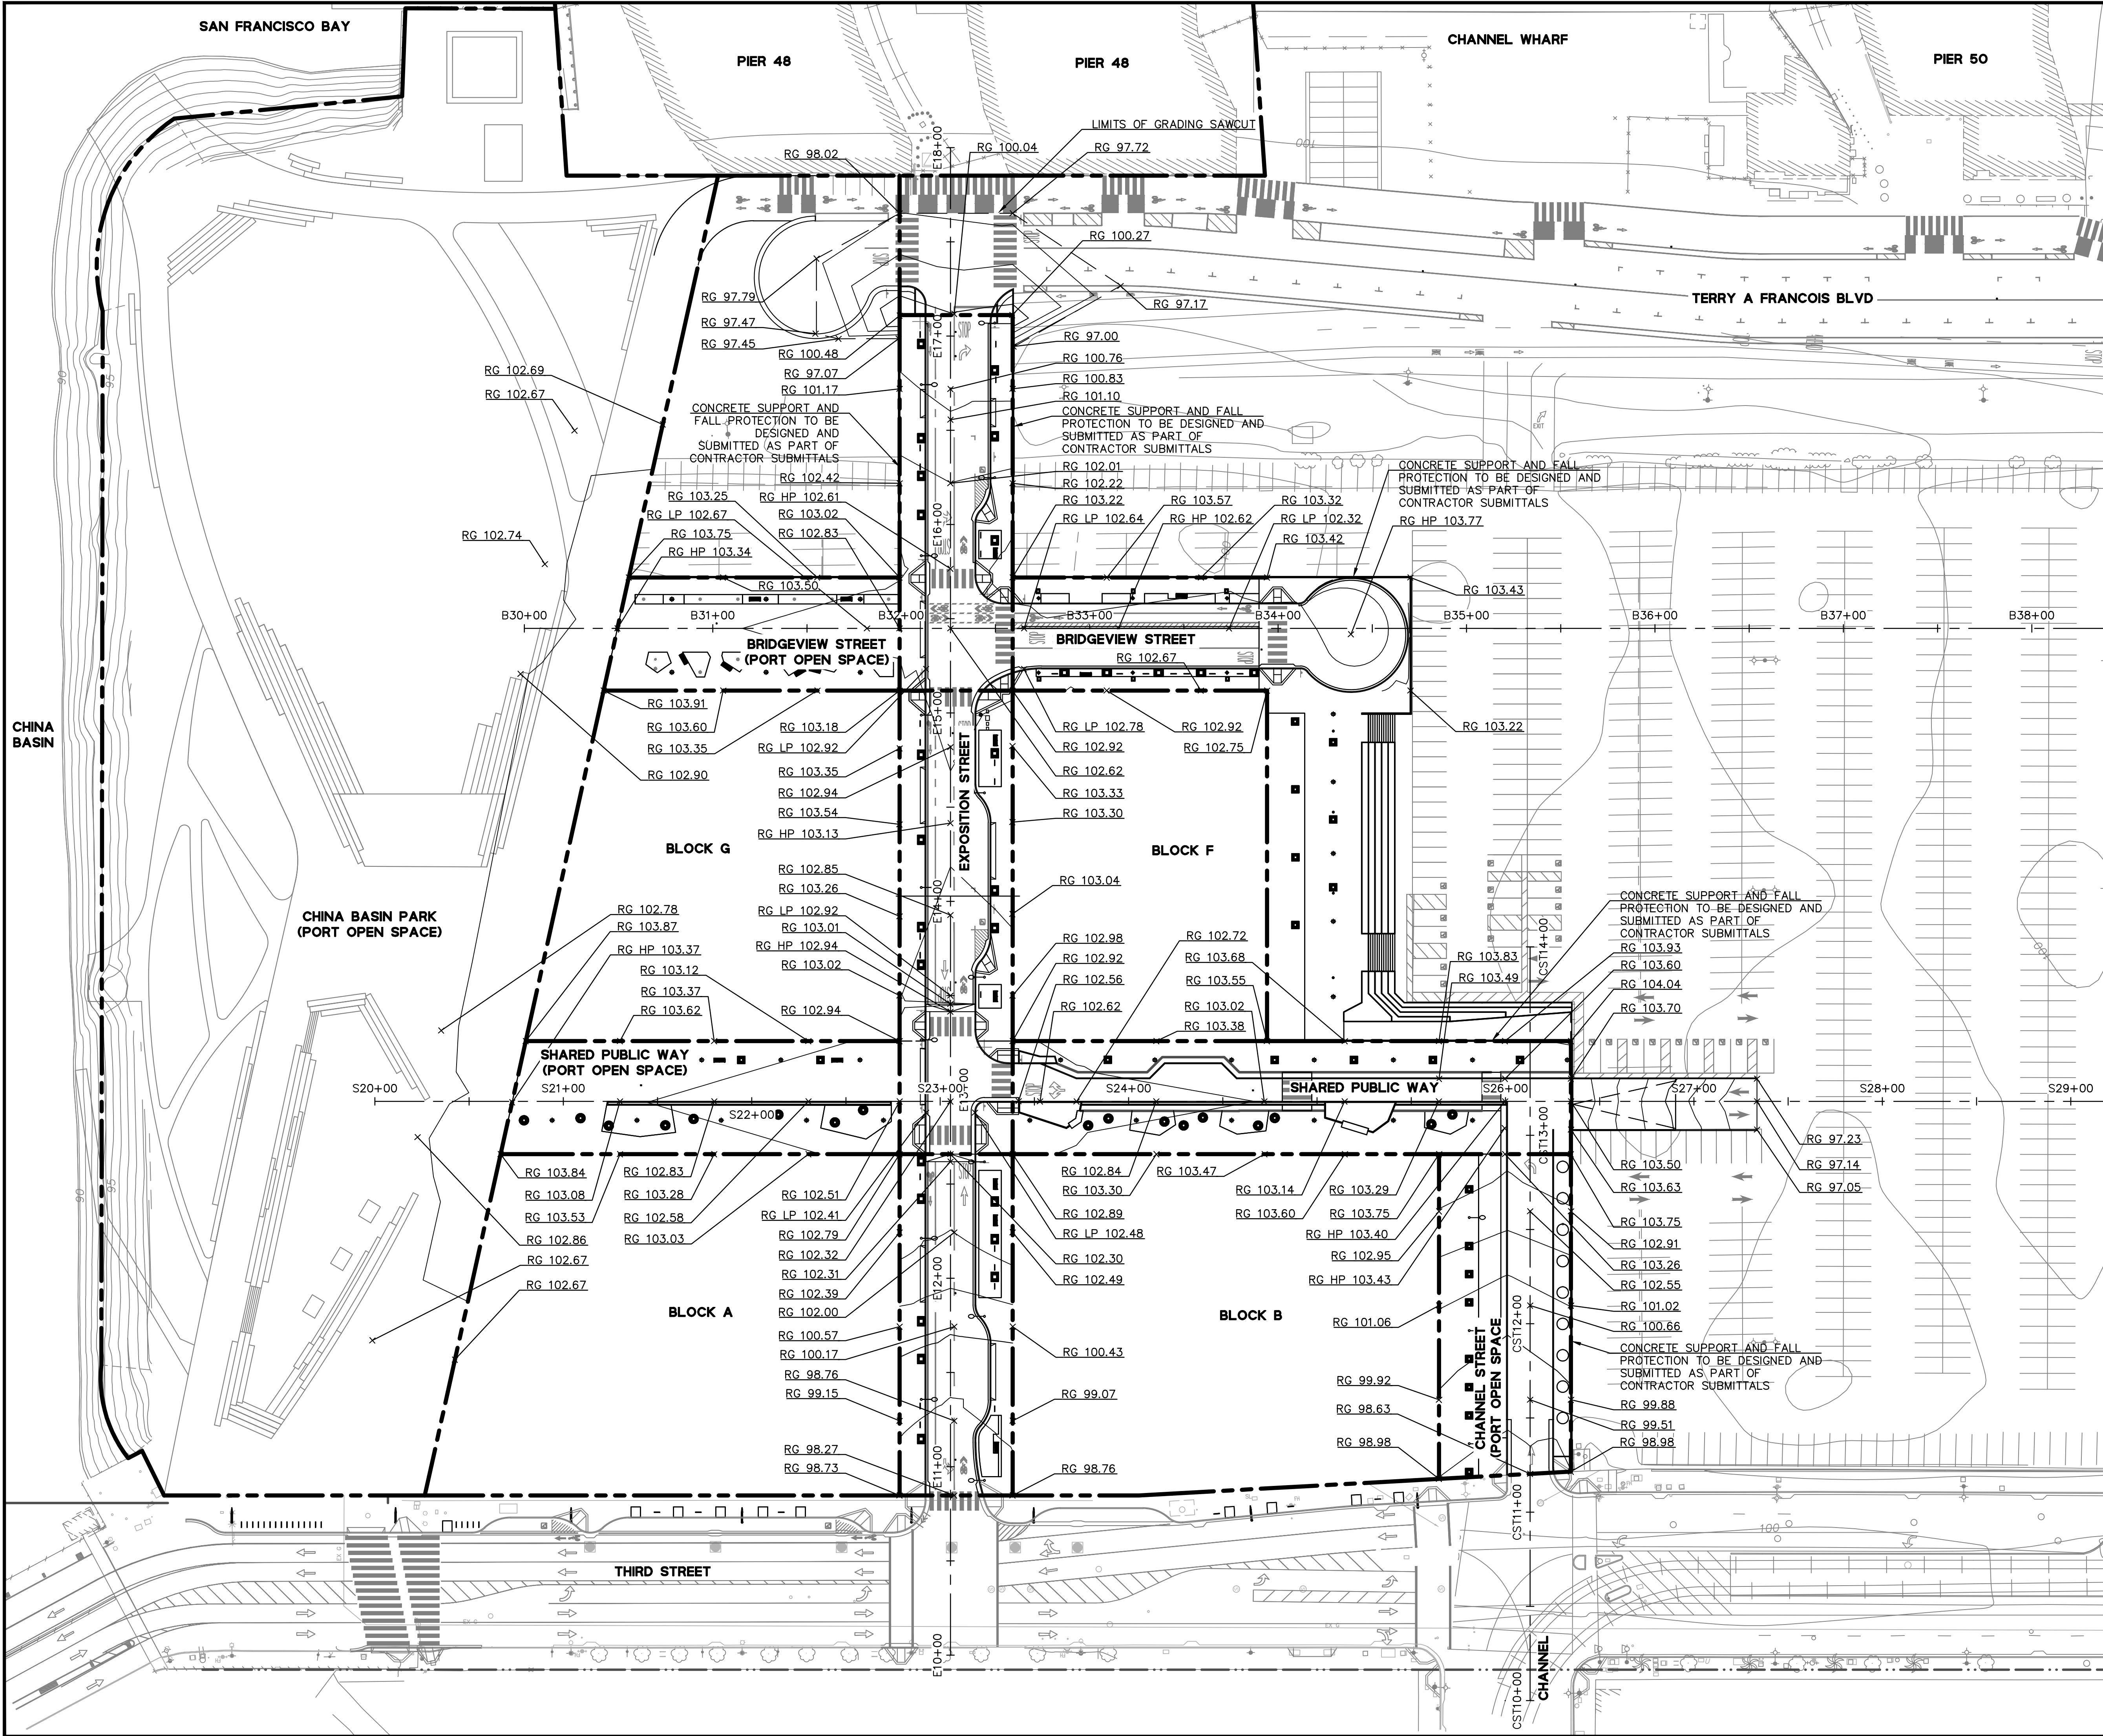

ROUGH GRADING NOTES

1. SEE GEOTECHNICAL AND EARTHWORK GRADING NOTES SHOWN ON SHEET G1.02.
2. CONTRACTOR SHALL PROVIDE PROPER SHORING OR TEMPORARY SLOPE DURING EXCAVATION OPERATIONS.
3. EXCAVATE AND FILL TO SUBGRADE ELEVATION. SUBGRADE ELEVATION SHALL BE THE THICKNESS OF THE STRUCTURAL SECTION BELOW THE FINISHED GRADE, AS SHOWN ON C9.08. THE ROUGH GRADE (RG) ELEVATIONS SHOWN ON C5.00 REFER TO THE BOTTOM OF THE AGGREGATE BASE AND THE TOP OF THE LIGHTWEIGHT CELLULAR CONCRETE (LCC), WHICH IS APPROXIMATELY 16' BELOW FINISHED GRADE.
4. REFER TO SHEETS C6.00 THROUGH C6.11 FOR DETAILED FINAL GRADING.
5. PRIOR TO ROUGH GRADING THE SITE, STONE COLUMNS WILL BE INSTALLED AS DIRECTED BY THE GEOTECHNICAL ENGINEER. THE LAYOUT OF THE STONE COLUMNS CAN BE SEEN ON SHEET C5.03.
6. THE BOTTOM OF THE LCC (BLCC) WILL BE DESIGNED BY THE GEOTECHNICAL ENGINEER.
7. THE FOLLOWING EARTHWORK QUANTITIES AND AREAS SHOWN BELOW ARE APPROXIMATE. ALL QUANTITIES ARE SUBJECT TO CHANGE, AND ALL QUANTITIES TO BE FIELD VERIFIED BASED ON FINAL CONDITION OF SITE AND CONTRACTOR'S MEANS AND METHODS. STRUCTURAL FOOTINGS, LANDSCAPE AND UTILITY TRENCHING ARE NOT PART OF THIS PARKAGE AND IS NOT INCLUDED.
8. REFER TO SHEETS C11.01 AND C11.02 FOR EROSION AND SEDIMENT CONTROL REQUIREMENTS.
9. WHERE UNSTABLE OR UNSUITABLE MATERIALS ARE ENCOUNTERED DURING SUBGRADE PREPARATION, IMMEDIATELY NOTIFY THE GEOTECHNICAL ENGINEER. THE AREA IN QUESTION SHALL BE OVER EXCAVATED AND REPLACED BY SELECTED BACKFILL MATERIAL, AS DIRECTED IN THE FIELD BY THE GEOTECHNICAL ENGINEER.

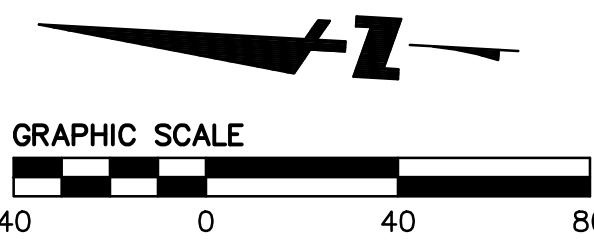

MISSION ROCK PHASE 1
STREET IMPROVEMENT PLANS
ROUGH GRADING AND LCC PLAN - TOP OF LCC


Revisions		No.	
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Date	6/17/2019	Scale	AS SHOWN
Design	JW	Drawn	KCC/JM
Approved	JD	Job No	20080006
Drawing Number:		C5.00	
		50 OF 283	

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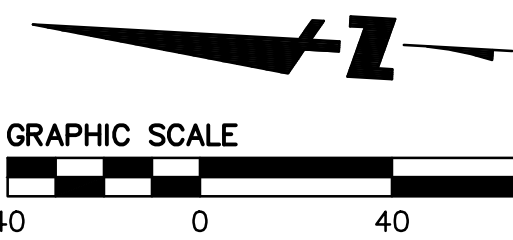
SAN FRANCISCO COUNTY CALIFORNIA

DRAWING NAME: \\Bkf-st\vol4\2008\080006_Mission_Rock\ENG\SIP\PLOTTED SHEETS\C5.00 - ROUGH GRADING PLAN.dwg
PLOT DATE: 06-16-19 PLOTTED BY: meyj



ROUGH GRADING NOTES

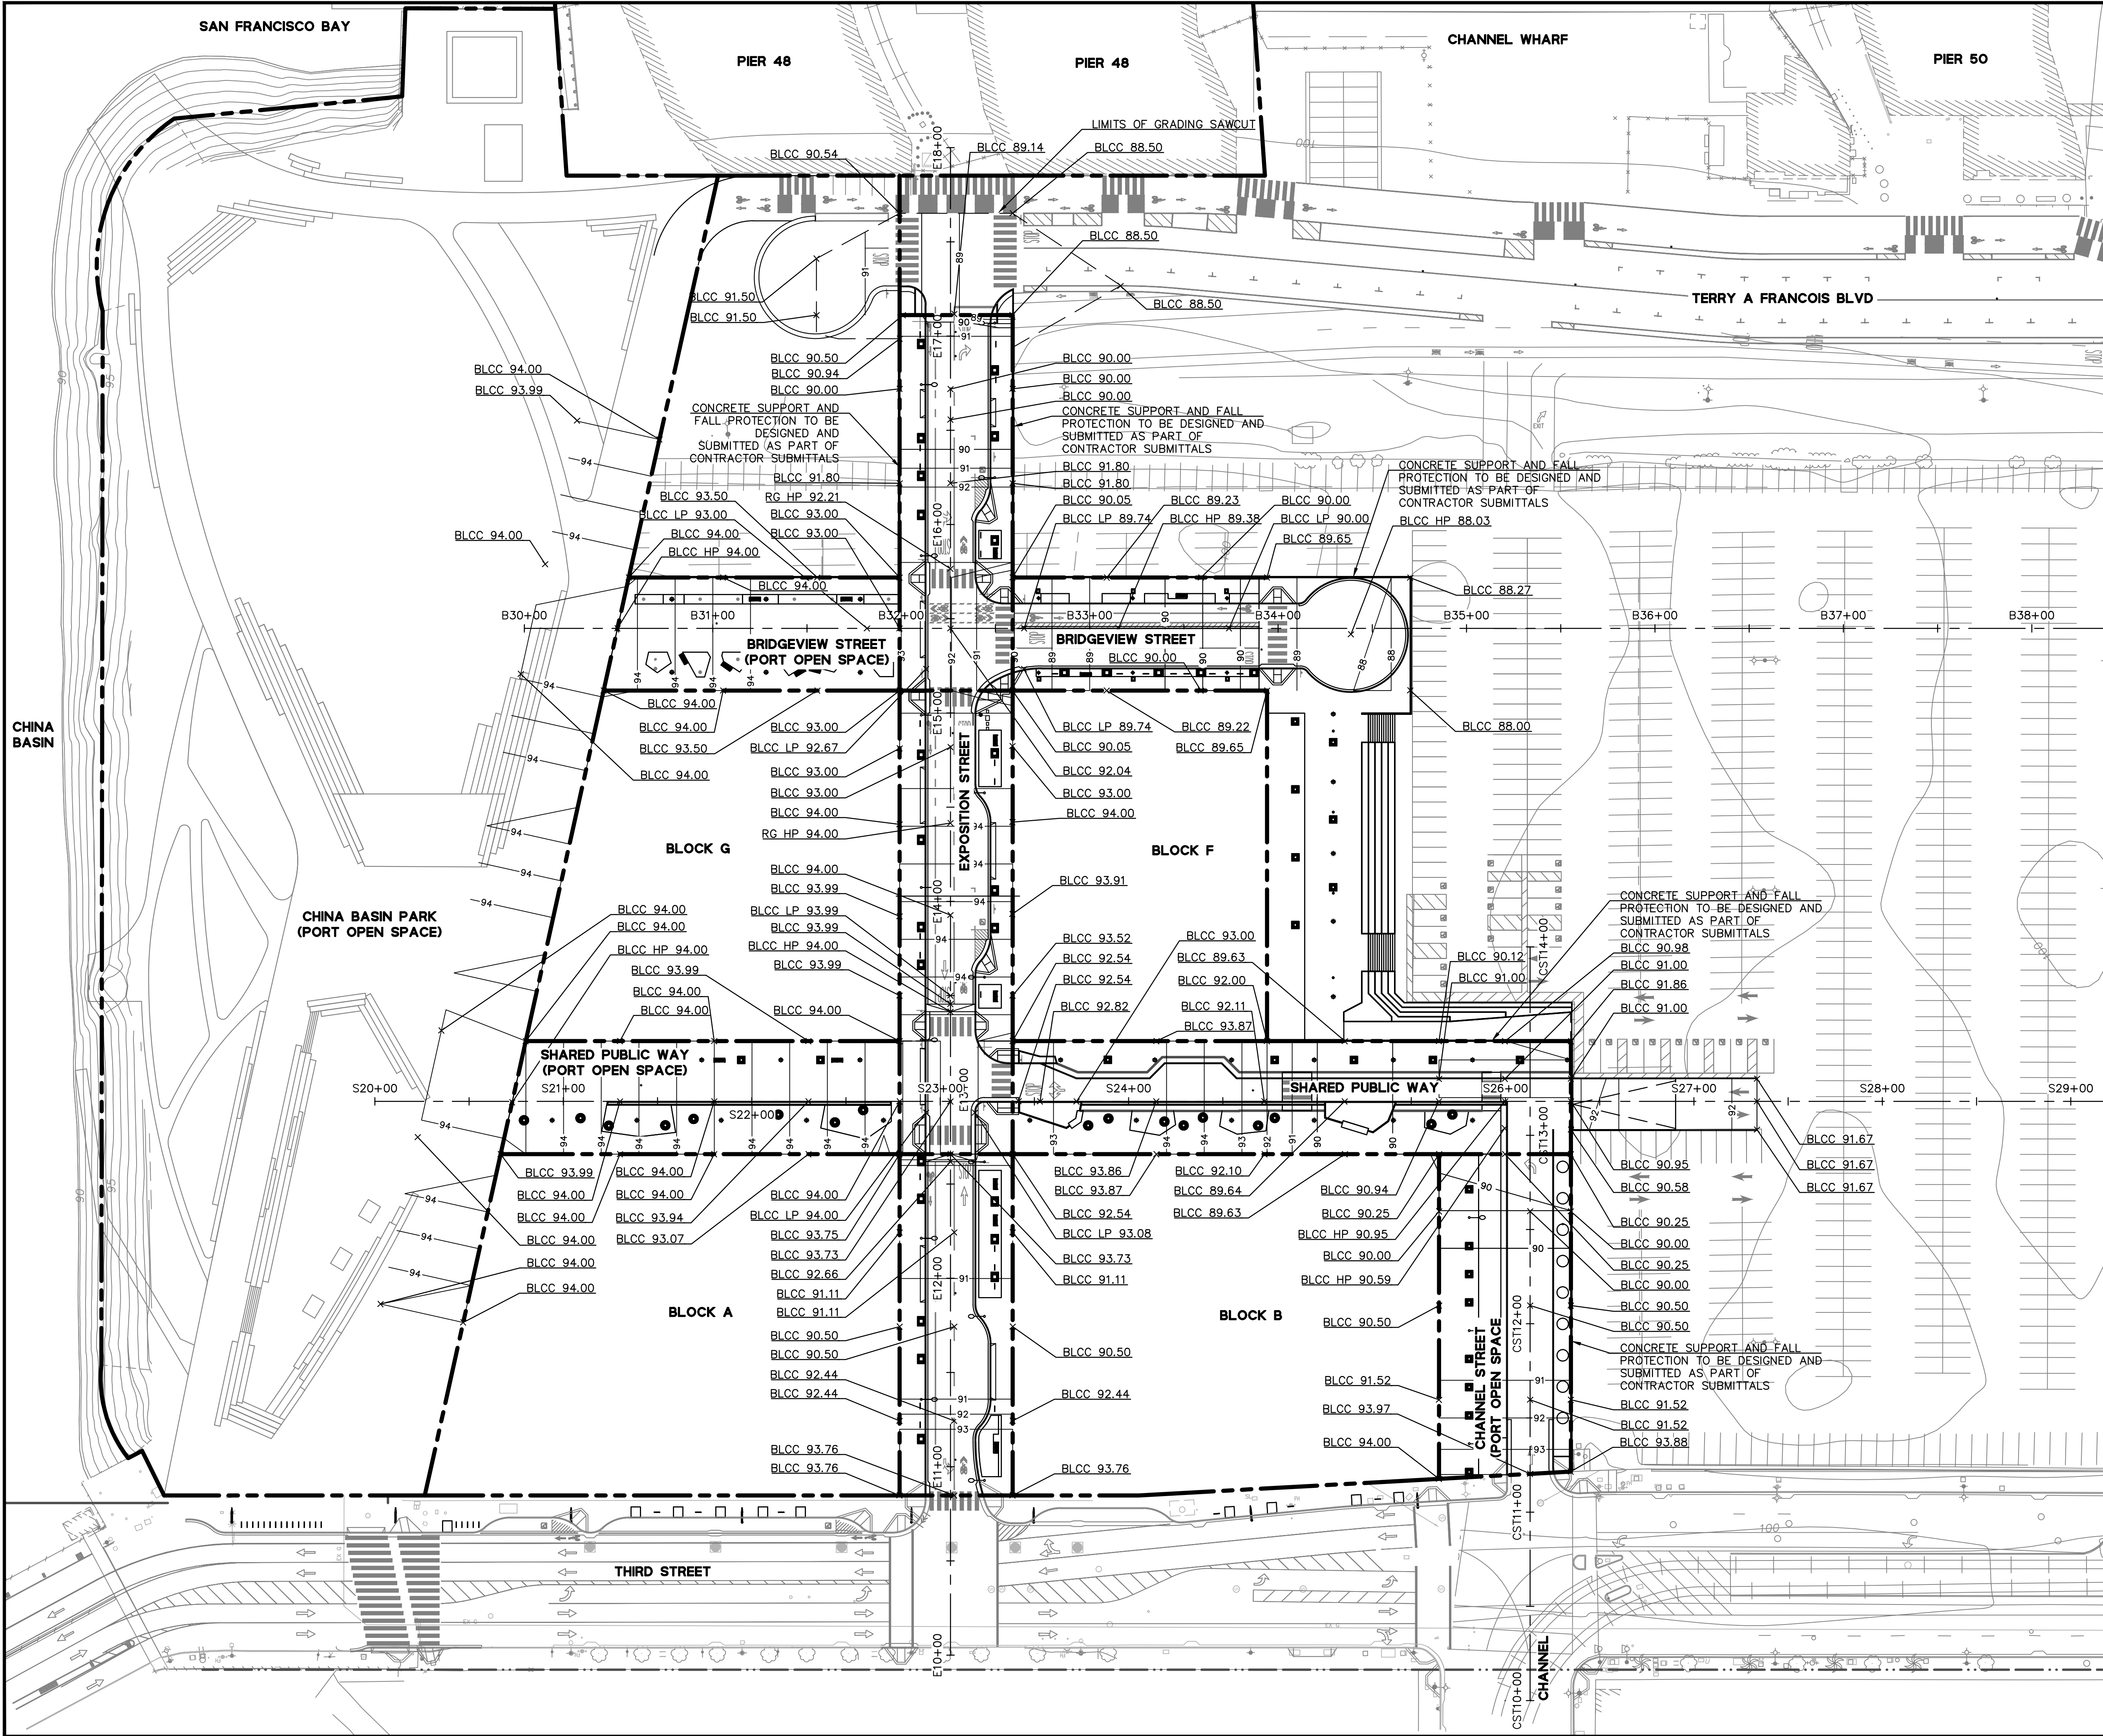1. SEE GEOTECHNICAL AND EARTHWORK GRADING NOTES SHOWN ON SHEET G1.02.
2. CONTRACTOR SHALL PROVIDE PROPER SHORING OR TEMPORARY SLOPE DURING EXCAVATION OPERATIONS.
3. EXCAVATE AND FILL TO SUBGRADE ELEVATION. SUBGRADE ELEVATION SHALL BE THE THICKNESS OF THE STRUCTURAL SECTION BELOW THE FINISHED GRADE, AS SHOWN ON C9.08. THE ROUGH GRADE (RG) ELEVATIONS SHOWN ON C5.00 REFER TO THE BOTTOM OF THE AGGREGATE BASE AND THE TOP OF THE LIGHTWEIGHT CELLULAR CONCRETE (LCC), WHICH IS APPROXIMATELY 16' BELOW FINISHED GRADE.
4. REFER TO SHEETS C6.00 THROUGH C6.11 FOR DETAILED FINAL GRADING.
5. PRIOR TO ROUGH GRADING THE SITE, STONE COLUMNS WILL BE INSTALLED AS DIRECTED BY THE GEOTECHNICAL ENGINEER. THE LAYOUT OF THE STONE COLUMNS CAN BE SEEN ON SHEET C5.03.
6. THE BOTTOM OF THE LCC (BLCC) WILL BE DESIGNED BY THE GEOTECHNICAL ENGINEER.
7. THE FOLLOWING EARTHWORK QUANTITIES AND AREAS SHOWN BELOW ARE APPROXIMATE. ALL QUANTITIES ARE SUBJECT TO CHANGE, AND ALL QUANTITIES TO BE FIELD VERIFIED BASED ON FINAL CONDITION OF SITE AND CONTRACTOR'S MEANS AND METHODS. STRUCTURAL FOOTINGS, LANDSCAPE AND UTILITY TRENCHING ARE NOT PART OF THIS PARKAGE AND IS NOT INCLUDED.
8. REFER TO SHEETS C11.01 AND C11.02 FOR EROSION AND SEDIMENT CONTROL REQUIREMENTS.
9. WHERE UNSTABLE OR UNSUITABLE MATERIALS ARE ENCOUNTERED DURING SUBGRADE PREPARATION, IMMEDIATELY NOTIFY THE GEOTECHNICAL ENGINEER. THE AREA IN QUESTION SHALL BE OVER EXCAVATED AND REPLACED BY SELECTED BACKFILL MATERIAL, AS DIRECTED IN THE FIELD BY THE GEOTECHNICAL ENGINEER.



**MISSION ROCK PHASE 1
STREET IMPROVEMENT PLANS**

ROUGH GRADING AND LCC PLAN - BOTTOM OF LCC


Revisions		No.	Date
STREET IMPROVEMENT PLANS - PHASE 1			
Scale AS SHOWN	JW		6/17/2019
Design	KCC/JM		
Drawn	KCC/JM		
Approved	JD		
Job No	20080006		
Drawing Number:	C5.01		
	51 OF 283		

FIRST SUBMITTAL - NOT FOR CONSTRUCTION




SAN FRANCISCO COUNTY CALIFORNIA

DRAWING NAME: \\Bkf-sf\vol4\2008\080006_Mission_Rock\ENG\SIP\PLOTTED SHEETS\C5.00 - ROUGH GRADING PLAN.dwg
PLOT DATE: 06-16-19 PLOTTED BY: meyj

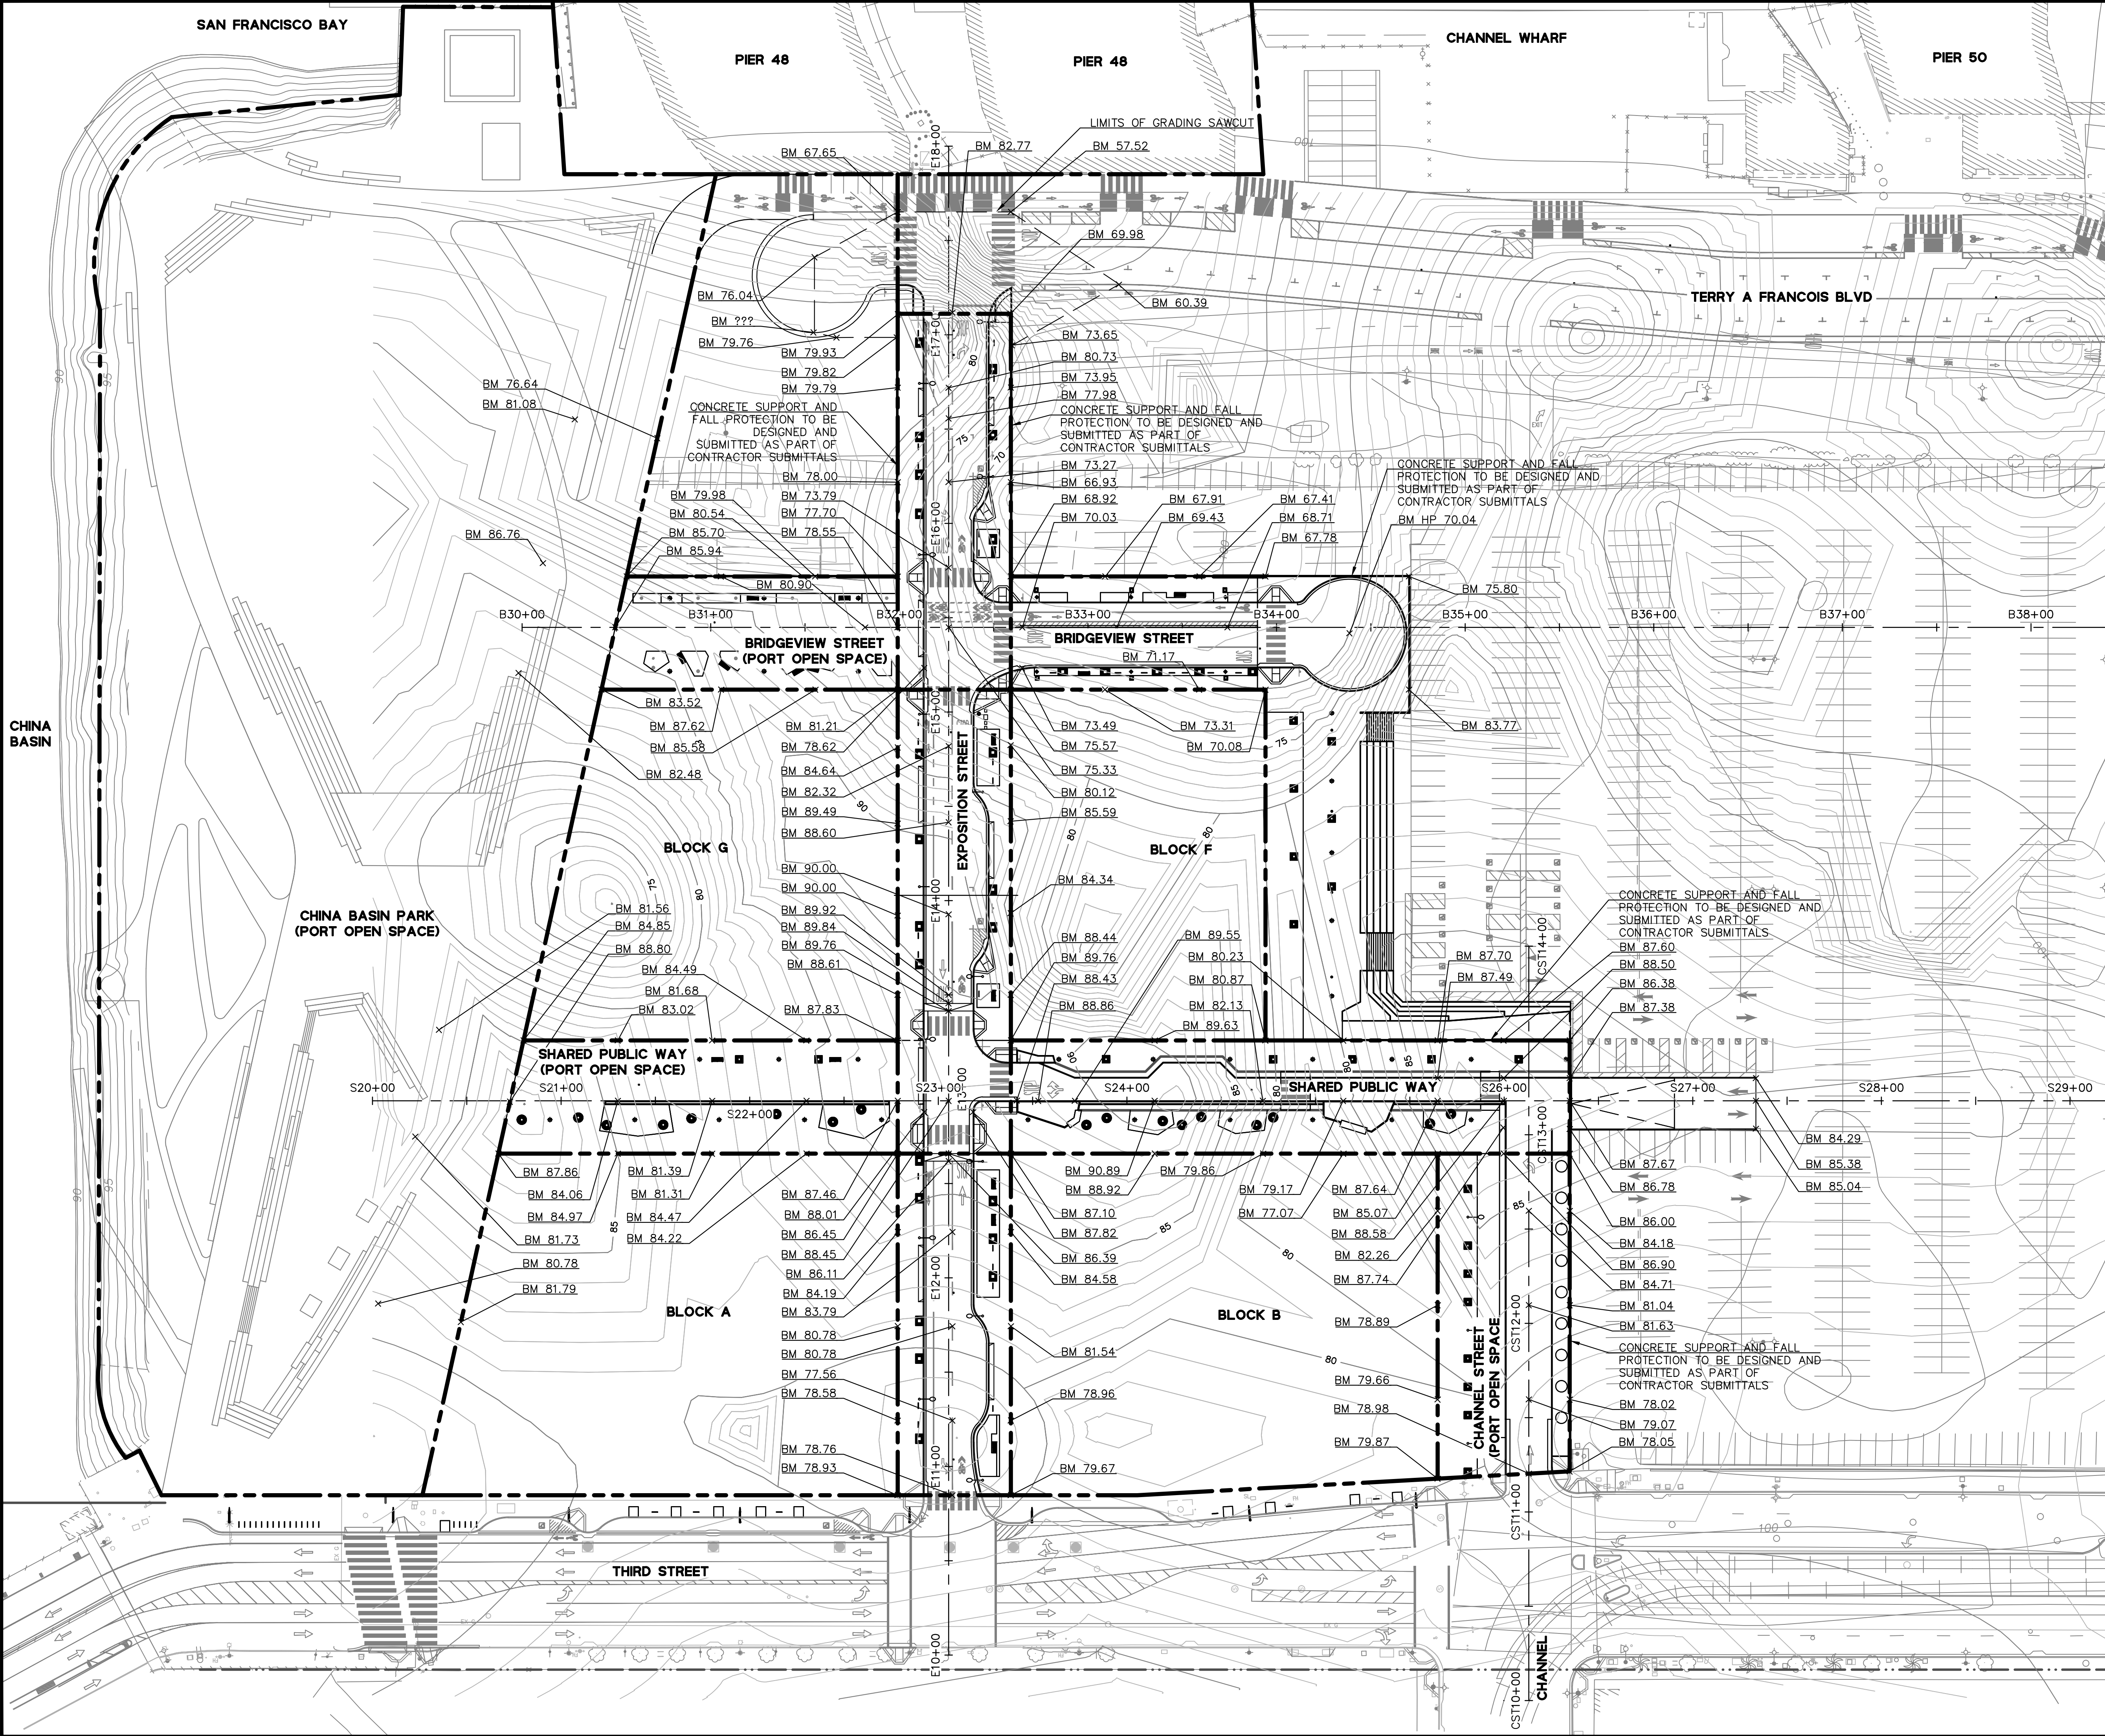

ROUGH GRADING NOTES

1. SEE GEOTECHNICAL AND EARTHWORK GRADING NOTES SHOWN ON SHEET G1.02.
2. CONTRACTOR SHALL PROVIDE PROPER SHORING OR TEMPORARY SLOPE DURING EXCAVATION OPERATIONS.
3. EXCAVATE AND FILL TO SUBGRADE ELEVATION. SUBGRADE ELEVATION SHALL BE THE THICKNESS OF THE STRUCTURAL SECTION BELOW THE FINISHED GRADE, AS SHOWN ON C9.08. THE ROUGH GRADE (RG) ELEVATIONS SHOWN ON C5.00 REFER TO THE BOTTOM OF THE AGGREGATE BASE AND THE TOP OF THE LIGHTWEIGHT CELLULAR CONCRETE (LCC), WHICH IS APPROXIMATELY 16" BELOW FINISHED GRADE.
4. REFER TO SHEETS C6.00 THROUGH C6.11 FOR DETAILED FINAL GRADING.
5. PRIOR TO ROUGH GRADING THE SITE, STONE COLUMNS WILL BE INSTALLED AS DIRECTED BY THE GEOTECHNICAL ENGINEER. THE LAYOUT OF THE STONE COLUMNS CAN BE SEEN ON SHEET C5.03.
6. THE BOTTOM OF THE LCC (BLOC) WILL BE DESIGNED BY THE GEOTECHNICAL ENGINEER.
7. THE FOLLOWING EARTHWORK QUANTITIES AND AREAS SHOWN BELOW ARE APPROXIMATE. ALL QUANTITIES ARE SUBJECT TO CHANGE, AND ALL QUANTITIES TO BE FIELD VERIFIED BASED ON FINAL CONDITION OF SITE AND CONTRACTOR'S MEANS AND METHODS. STRUCTURAL FOOTINGS, LANDSCAPE AND UTILITY TRENCHING ARE NOT PART OF THIS PARKAGE AND IS NOT INCLUDED.
8. REFER TO SHEETS C11.01 AND C11.02 FOR EROSION AND SEDIMENT CONTROL REQUIREMENTS.
9. WHERE UNSTABLE OR UNSUITABLE MATERIALS ARE ENCOUNTERED DURING SUBGRADE PREPARATION, IMMEDIATELY NOTIFY THE GEOTECHNICAL ENGINEER. THE AREA IN QUESTION SHALL BE OVER EXCAVATED AND REPLACED BY SELECTED BACKFILL MATERIAL, AS DIRECTED IN THE FIELD BY THE GEOTECHNICAL ENGINEER.

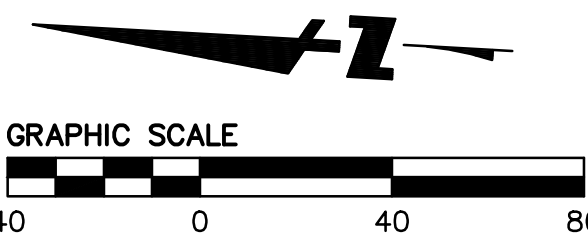

MISSION ROCK PHASE 1
STREET IMPROVEMENT PLANS
ROUGH GRADING AND LCC PLAN - EXISTING BAY MUD

Revisions		No.	Date
STREET IMPROVEMENT PLANS - PHASE 1			6/17/2019
Scale	AS SHOWN	JW	
Design		KCC/JM	
Drawn			
Approved		JD	
Job No	20080006		

Drawing Number:
C5.02
52 OF 283


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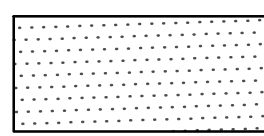
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PLOT DATE: 06-16-19 PLOTTED BY: meyj



ROUGH GRADING NOTES

1. SEE GEOTECHNICAL AND EARTHWORK GRADING NOTES SHOWN ON SHEET G1.02.
2. CONTRACTOR SHALL PROVIDE PROPER SHORING OR TEMPORARY SLOPE DURING EXCAVATION OPERATIONS.
3. EXCAVATE AND FILL TO SUBGRADE ELEVATION. SUBGRADE ELEVATION SHALL BE THE THICKNESS OF THE STRUCTURAL SECTION BELOW THE FINISHED GRADE, AS SHOWN ON C9.08. THE ROUGH GRADE (RG) ELEVATIONS SHOWN ON C5.00 REFER TO THE BOTTOM OF THE AGGREGATE BASE AND THE TOP OF THE LIGHTWEIGHT CELLULAR CONCRETE (LCC), WHICH IS APPROXIMATELY 16' BELOW FINISHED GRADE.
4. REFER TO SHEETS C6.00 THROUGH C6.11 FOR DETAILED FINAL GRADING.
5. PRIOR TO ROUGH GRADING THE SITE, STONE COLUMNS WILL BE INSTALLED AS DIRECTED BY THE GEOTECHNICAL ENGINEER. THE LAYOUT OF THE STONE COLUMNS CAN BE SEEN ON SHEET C5.03.
6. THE BOTTOM OF THE LCC (BLOC) WILL BE DESIGNED BY THE GEOTECHNICAL ENGINEER.
7. THE FOLLOWING EARTHWORK QUANTITIES AND AREAS SHOWN BELOW ARE APPROXIMATE. ALL QUANTITIES ARE SUBJECT TO CHANGE, AND ALL QUANTITIES TO BE FIELD VERIFIED BASED ON FINAL CONDITION OF SITE AND CONTRACTOR'S MEANS AND METHODS. STRUCTURAL FOOTINGS, LANDSCAPE AND UTILITY TRENCHING ARE NOT PART OF THIS PARKAGE AND IS NOT INCLUDED.
8. REFER TO SHEETS C11.01 AND C11.02 FOR EROSION AND SEDIMENT CONTROL REQUIREMENTS.
9. WHERE UNSTABLE OR UNSUITABLE MATERIALS ARE ENCOUNTERED DURING SUBGRADE PREPARATION, IMMEDIATELY NOTIFY THE GEOTECHNICAL ENGINEER. THE AREA IN QUESTION SHALL BE OVER EXCAVATED AND REPLACED BY SELECTED BACKFILL MATERIAL, AS DIRECTED IN THE FIELD BY THE GEOTECHNICAL ENGINEER.



LEGEND

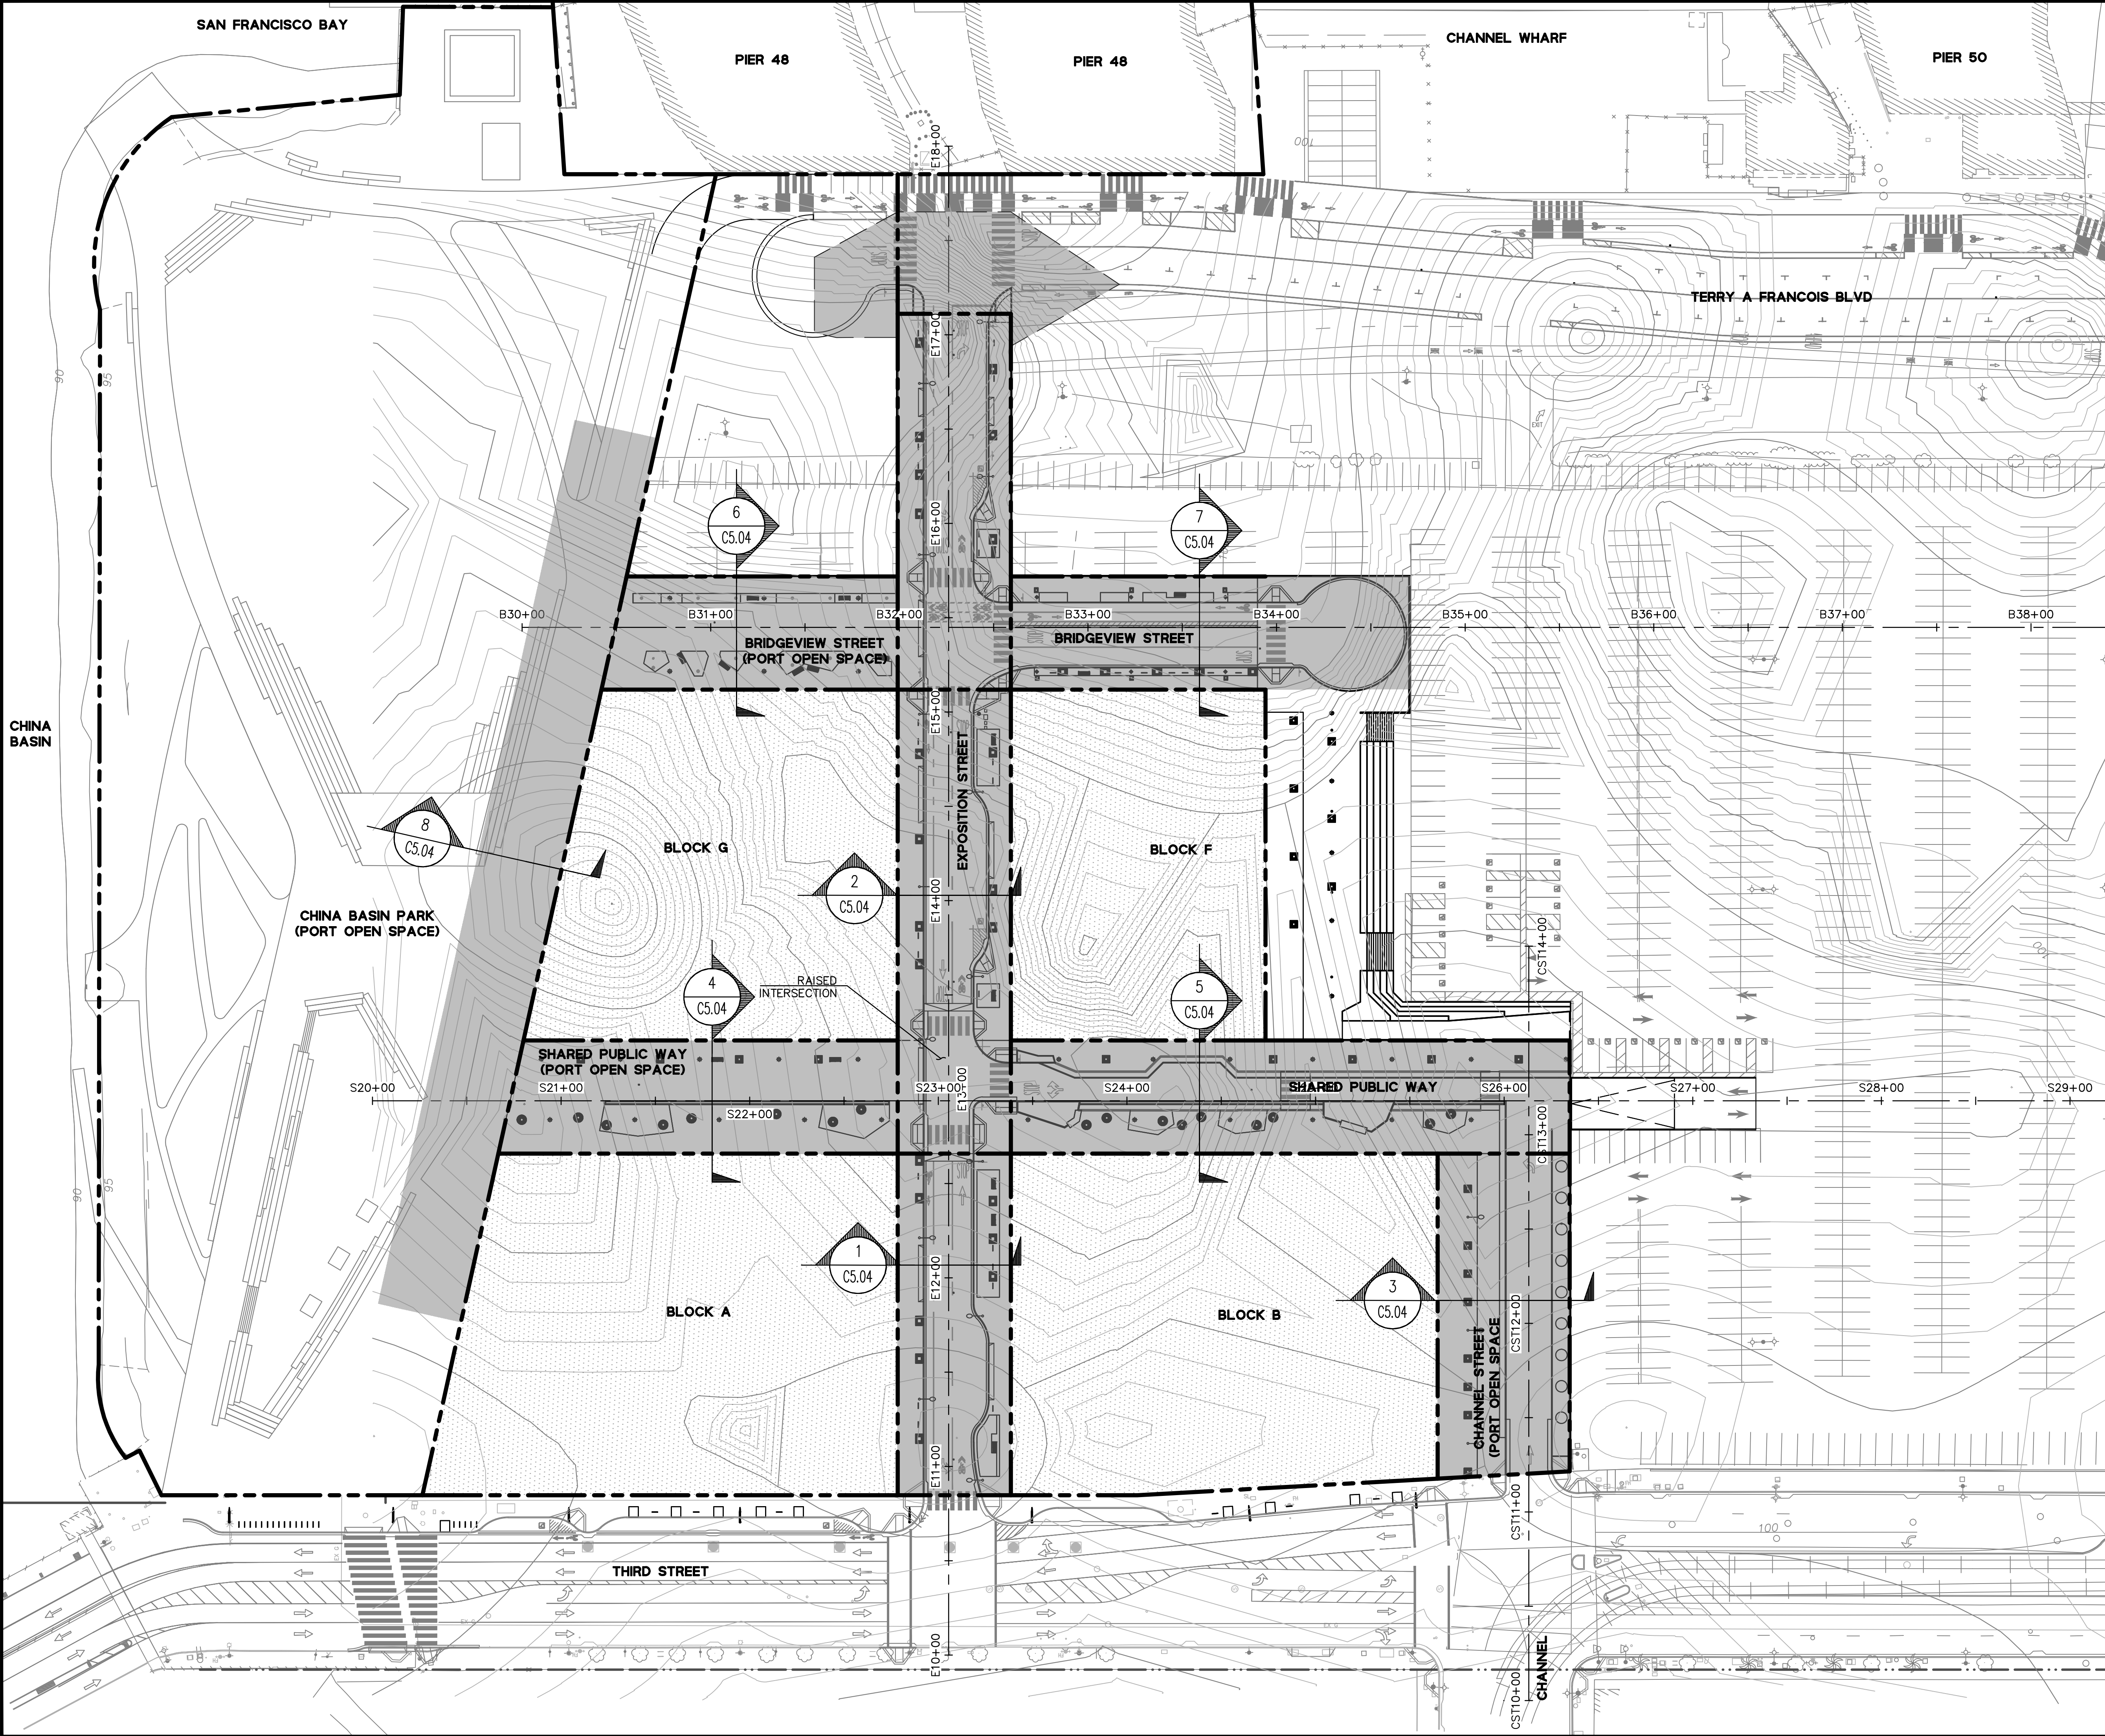

EXTENTS OF STONE COLUMNS UNDERNEATH THE BUILDING. SPACING AND LAYOUT TO BE DETERMINED BY GEOTECHNICAL ENGINEER AFTER FOUNDATION PLANS HAVE BEEN DESIGNED



EXTENTS OF STREET STONE COLUMNS, SPACING, AND LAYOUT TO BE DETERMINED BY GEOTECHNICAL ENGINEER AFTER TESTING HAS BEEN COMPLETED DURING CONSTRUCTION

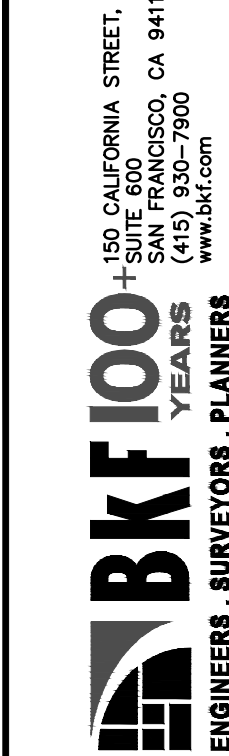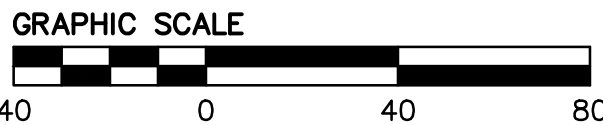

MISSION ROCK PHASE 1
STREET IMPROVEMENT PLANS
ROUGH GRADING AND LCC PLAN - STONE COLUMN LAYOUT

Revisions		No.	Date
STREET IMPROVEMENT PLANS - PHASE 1			6/17/2019
Scale	AS SHOWN	JW	
Design		KCC/JM	
Drawn		JD	
Approved			
Job No	20080006		

Drawing Number: **C5.03**




53 OF 283

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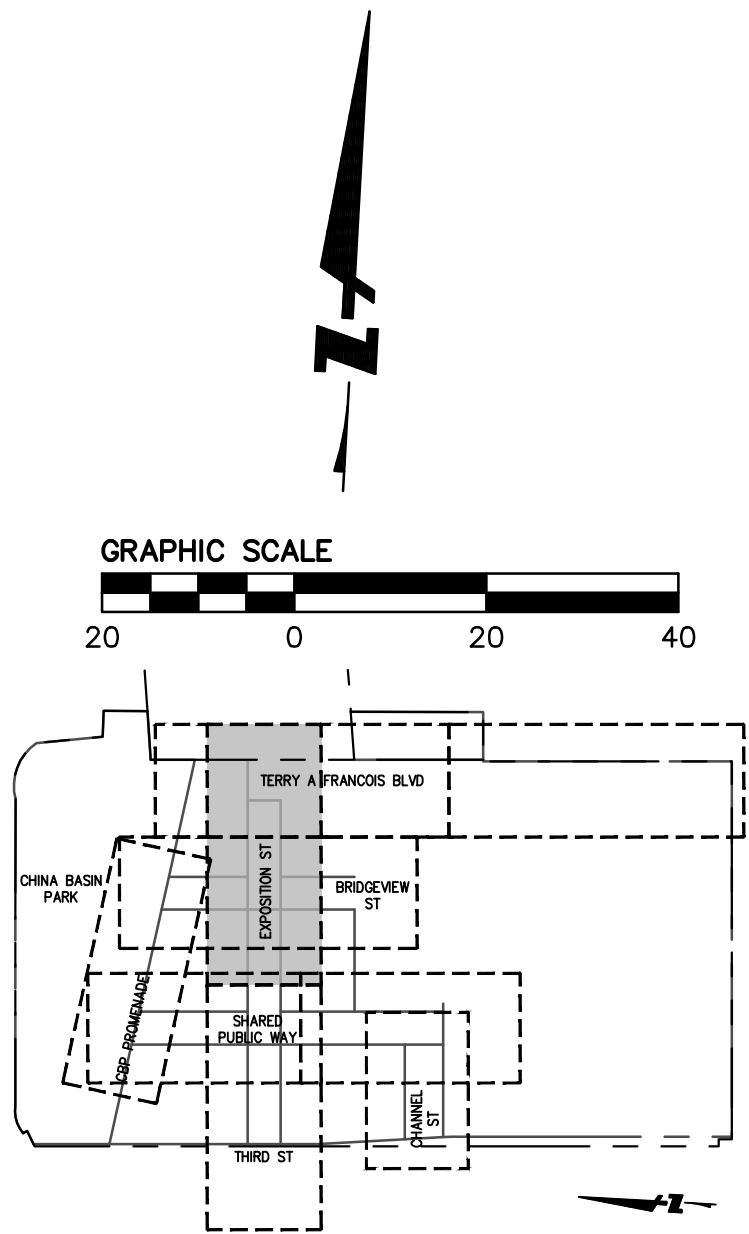
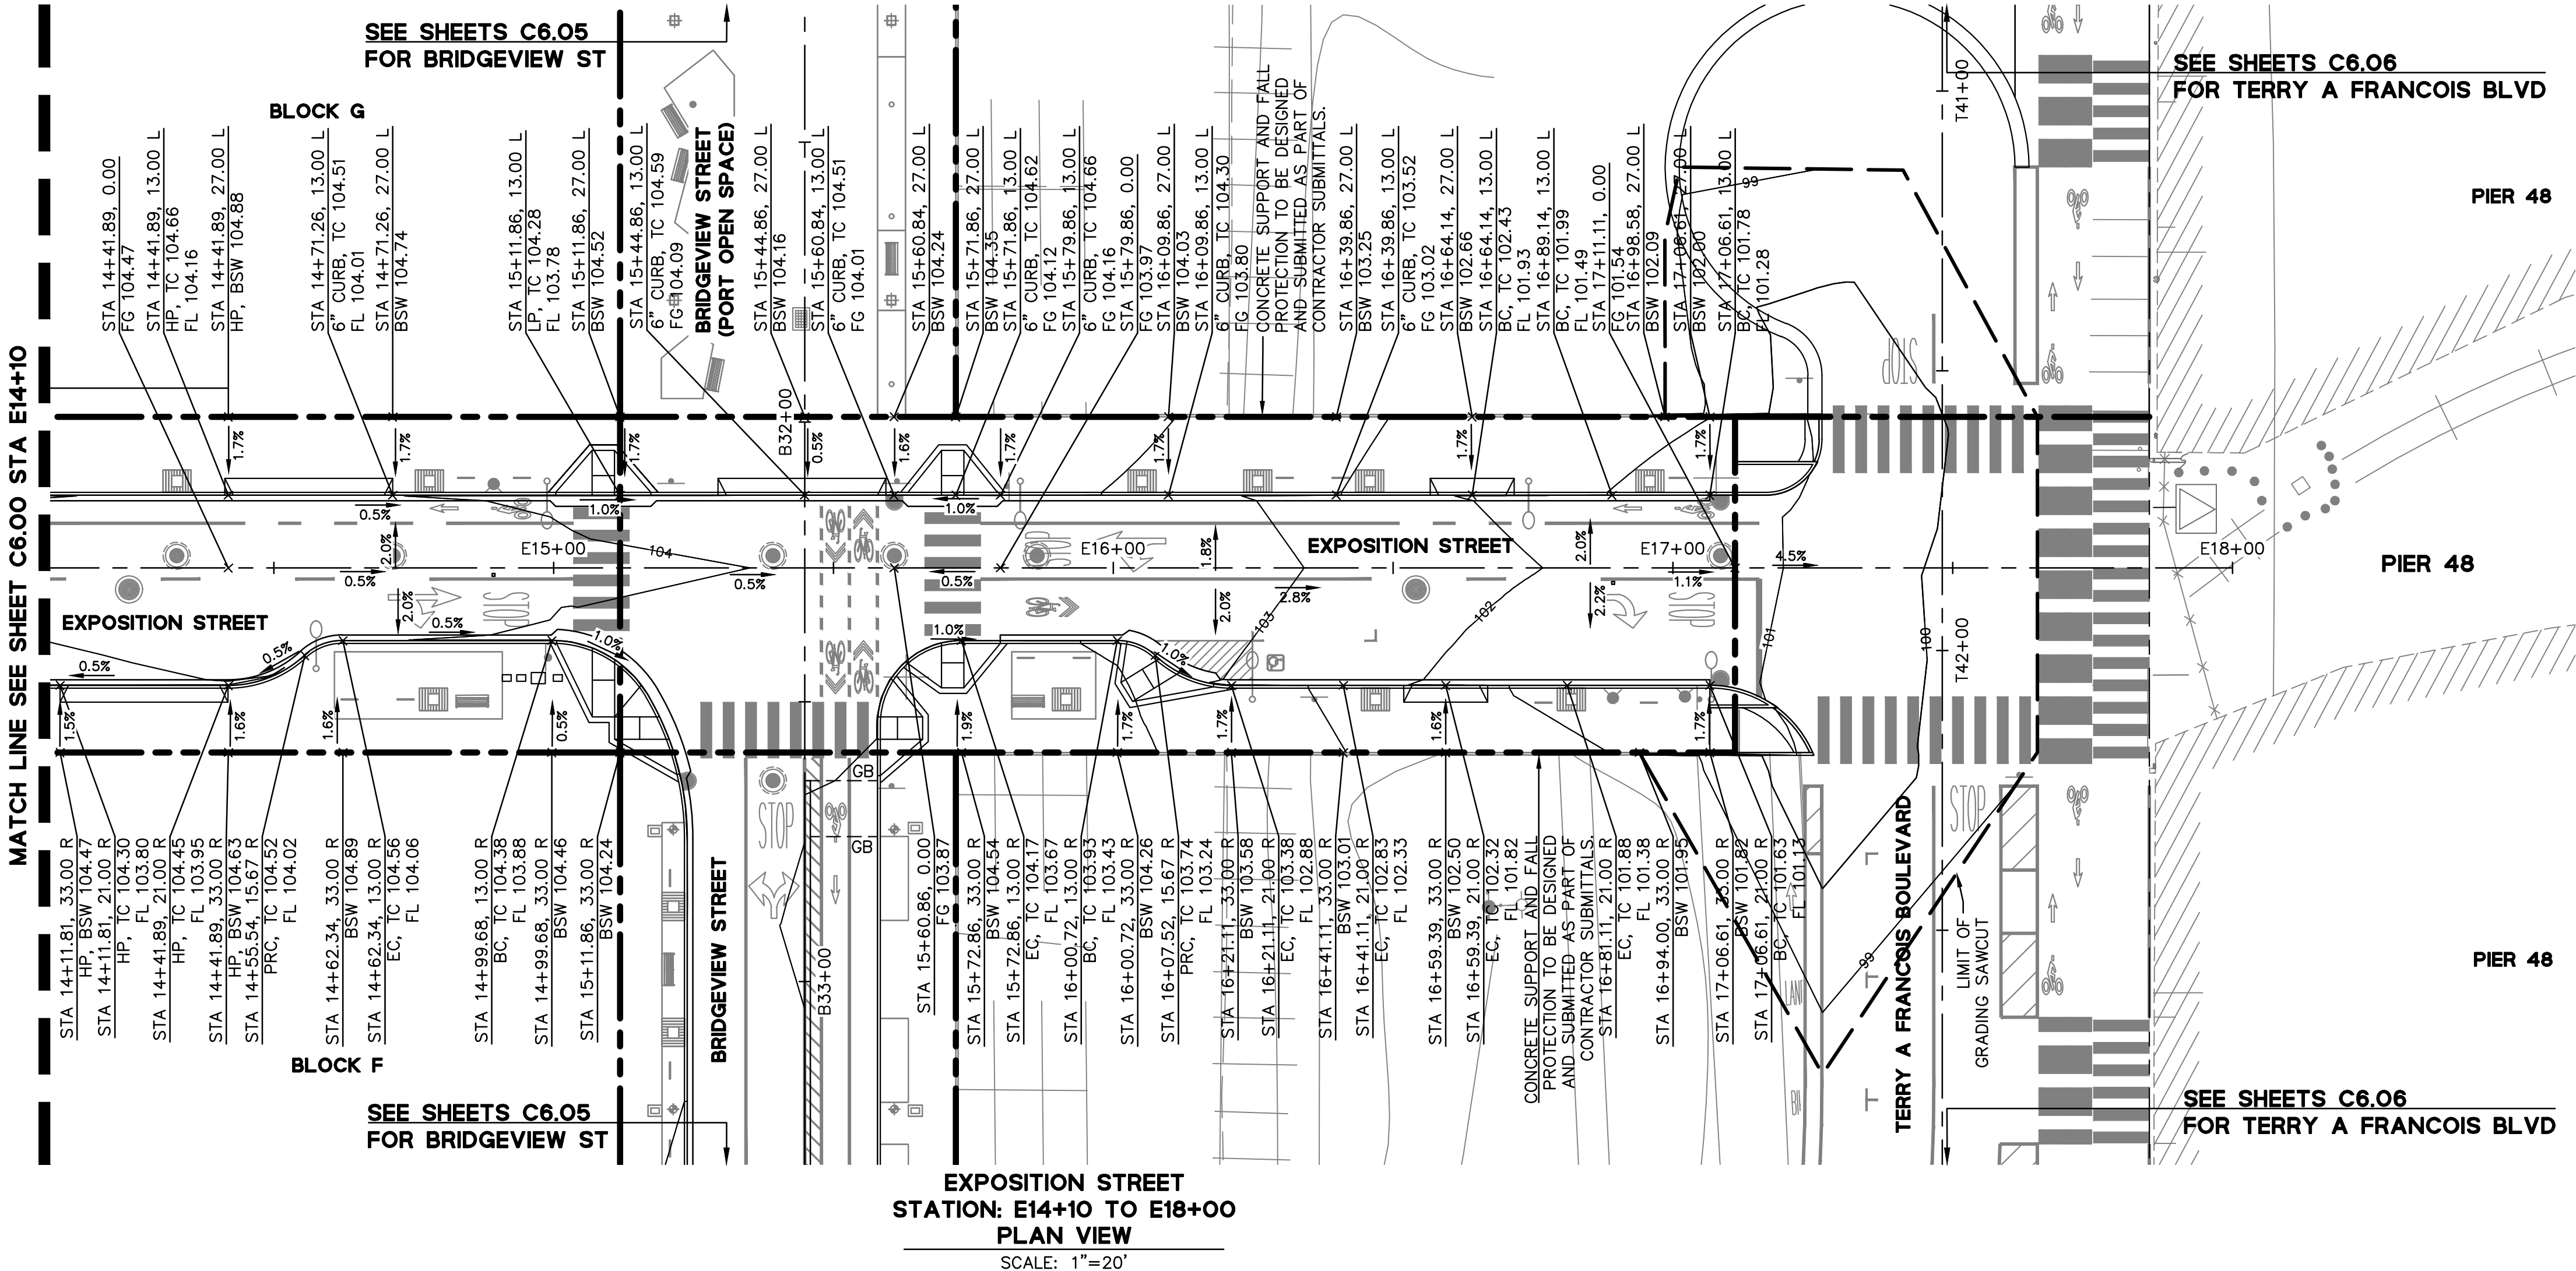
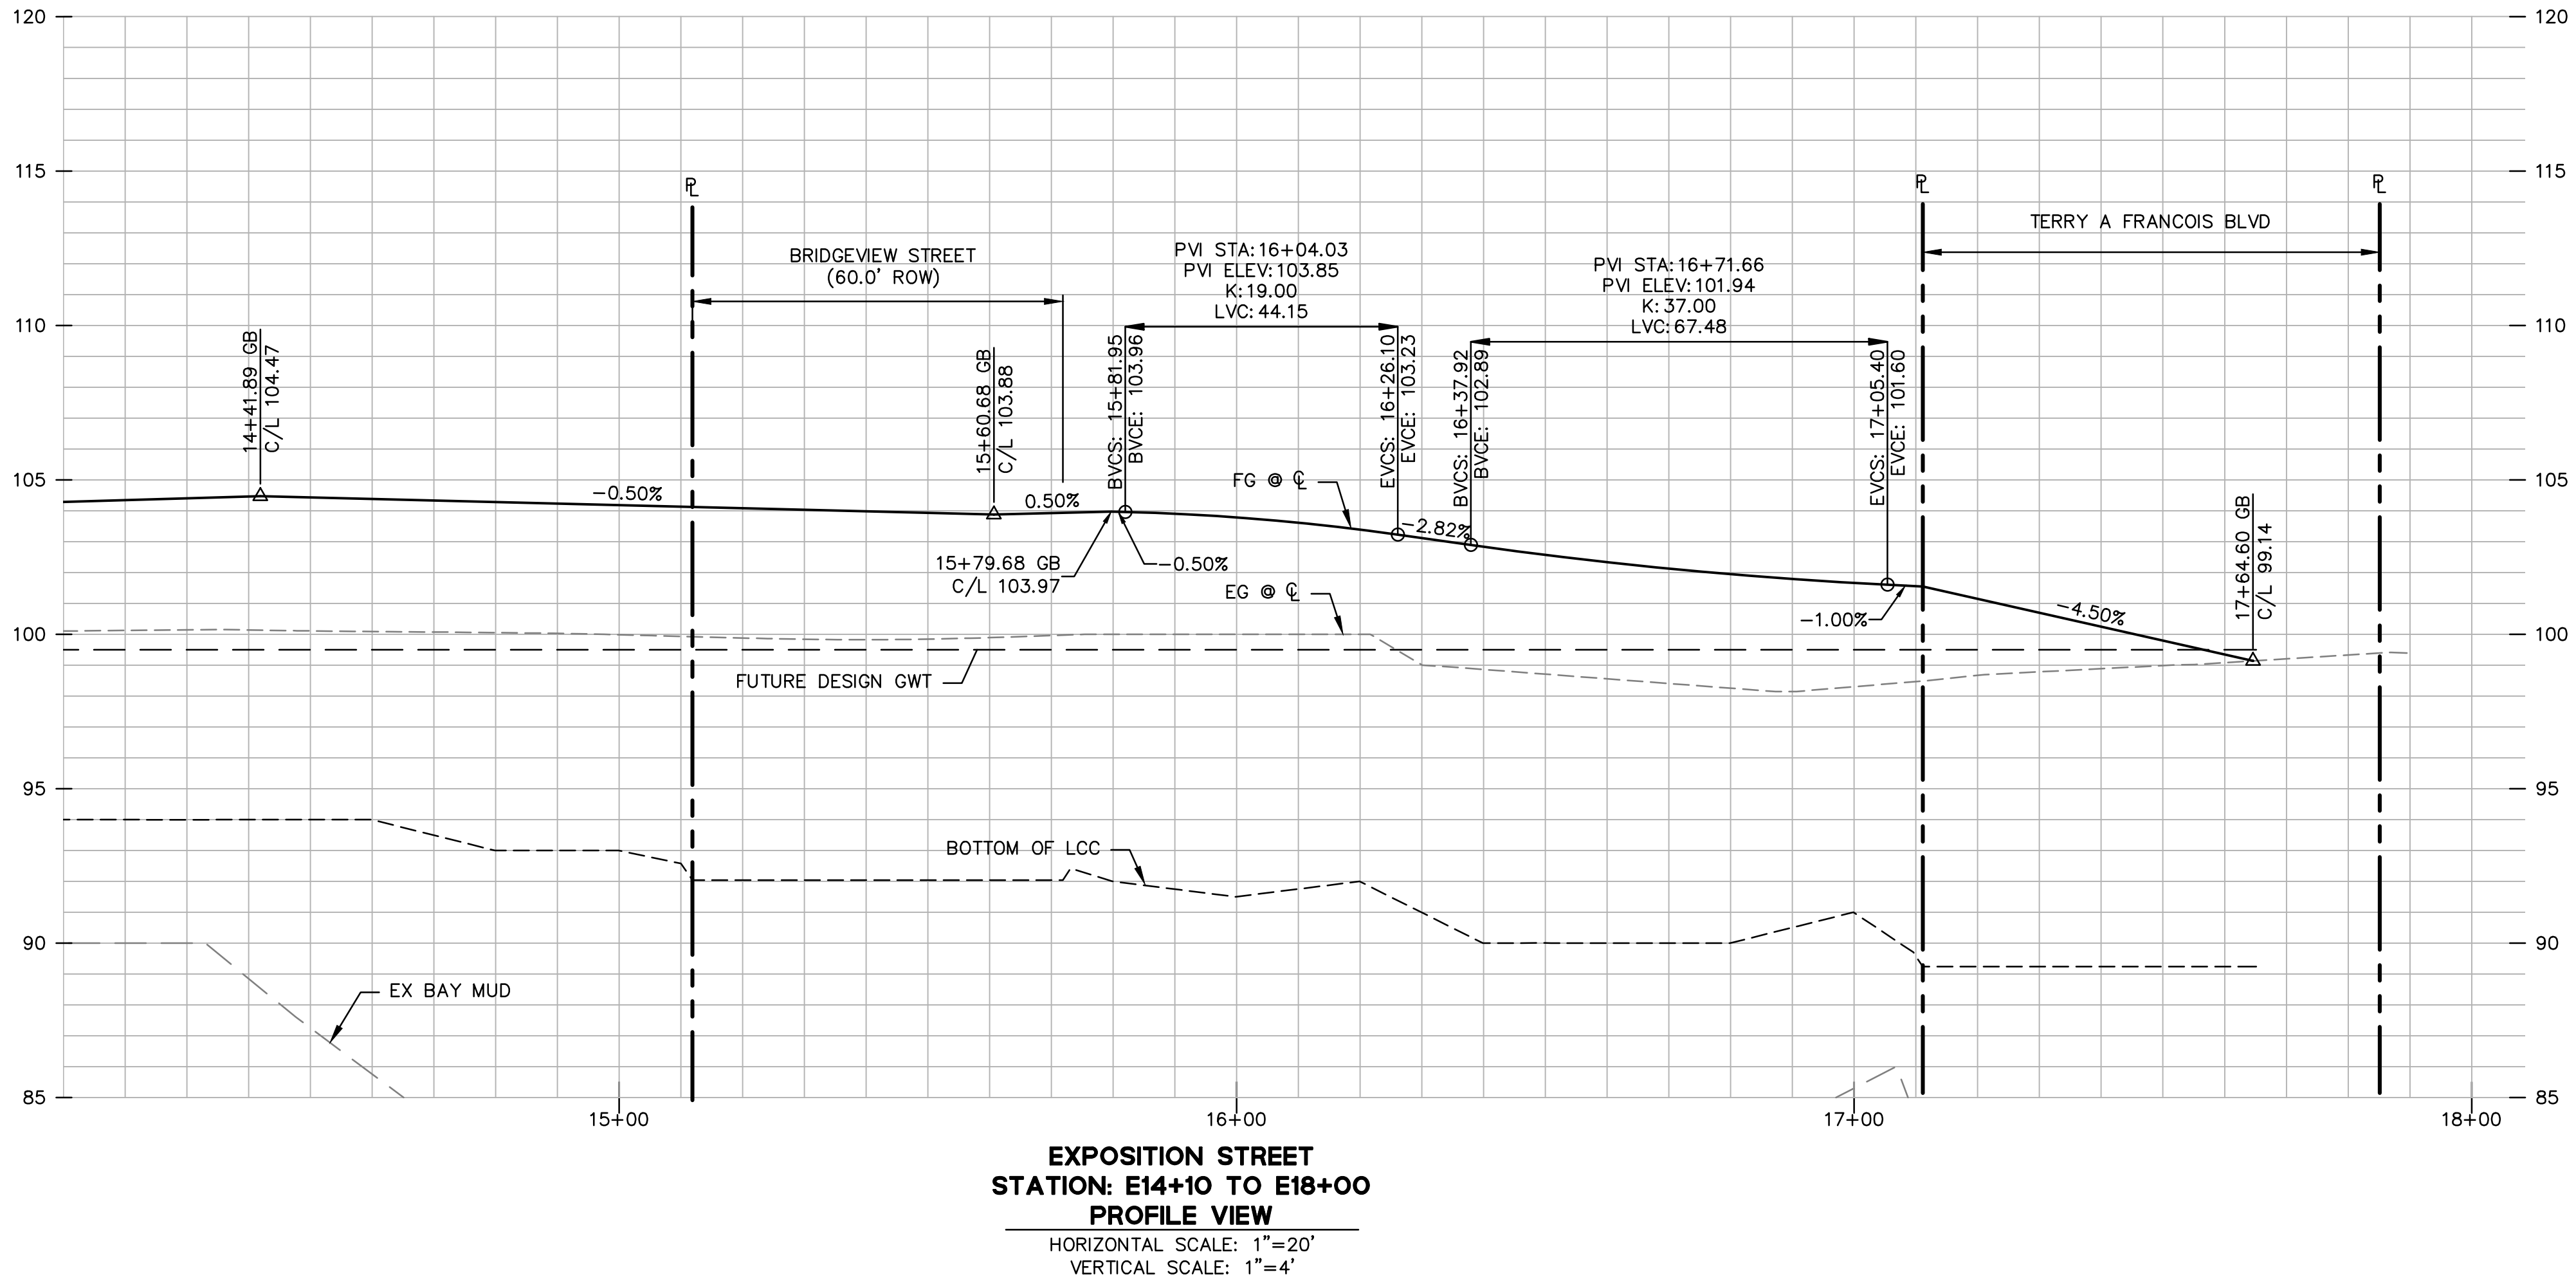
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DRAWING NAME: \\Bkf-stf\vol4\2008\080006_Mission Rock\ENG\SIP\PLOTTED SHEETS\C6.00 - GRADING PLAN.dwg

PLOT DATE: 06-16-19 PLOTTED BY: meyj



- GRADING NOTES**
1. ALL STATIONS AND OFFSETS SHOWN ON THIS STREET ARE REFERENCED FROM THE CENTERLINE ALIGNMENT.
 2. SEE SHEETS C6.07 THROUGH C6.11 FOR DETAILED GRADING AT ACCESSIBLE CURB RAMPS AND CROSSWALKS.
 3. FOR TYPICAL ROAD SECTIONS, SEE SHEETS C8.00 THROUGH C8.02.
 4. REFER TO GRADES SHOWN ON THE OFF-SITE THIRD STREET PLANS.
 5. CONTRACTOR TO PROVIDE FENCE OR CONCRETE FALL PROTECTION ADJACENT TO DEVELOPMENT PARCELS.
 6. SEE STORMWATER TREATMENT SHEETS C12.00 THROUGH C12.04 FOR ADDITIONAL GRADING INFORMATION.
 7. ALL LIGHTWEIGHT CELLULAR CONCRETE (LCC) INFORMATION SHOWN WILL BE DESIGNED AND PROVIDED BY THE GEOTECHNICAL ENGINEER.

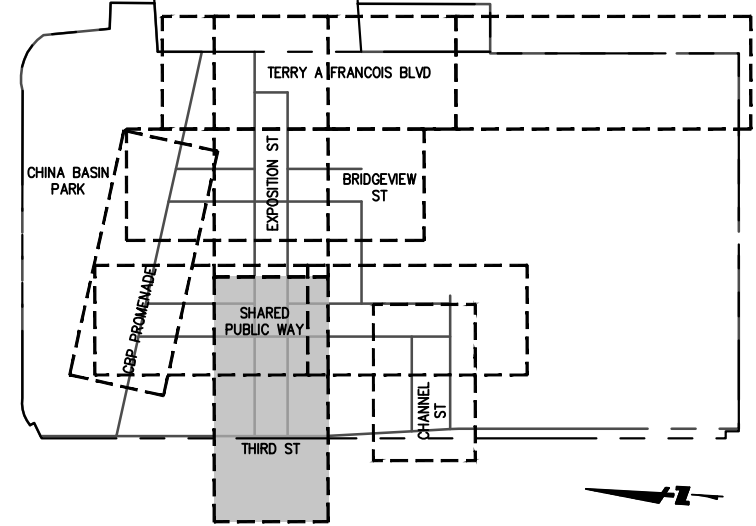
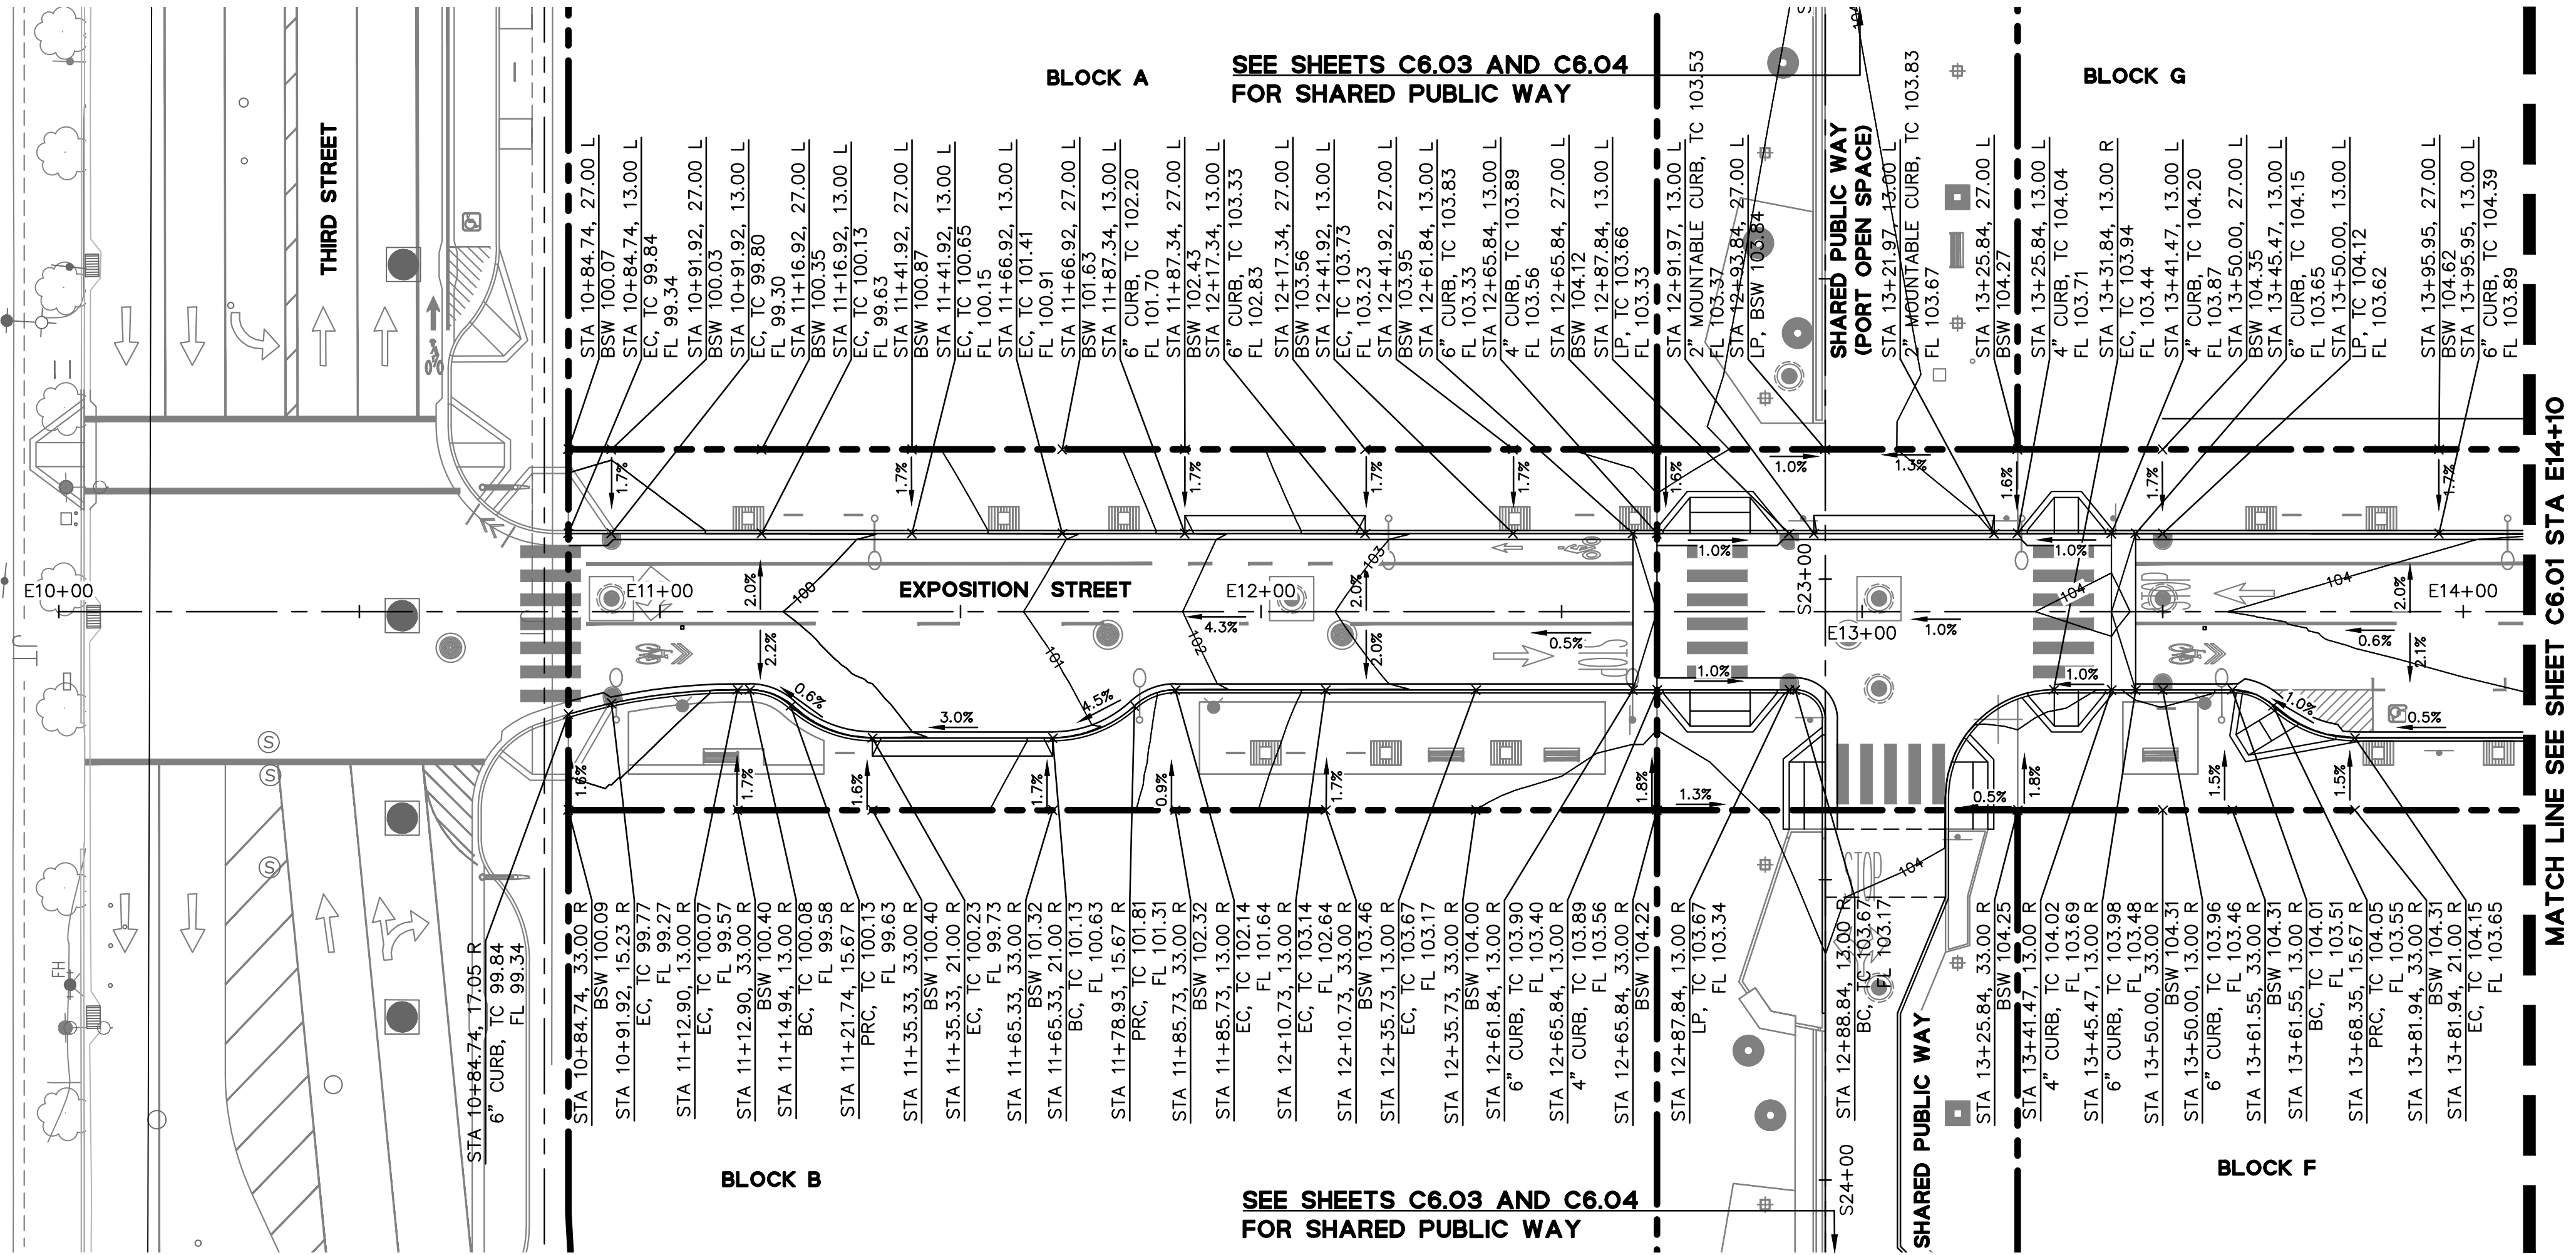
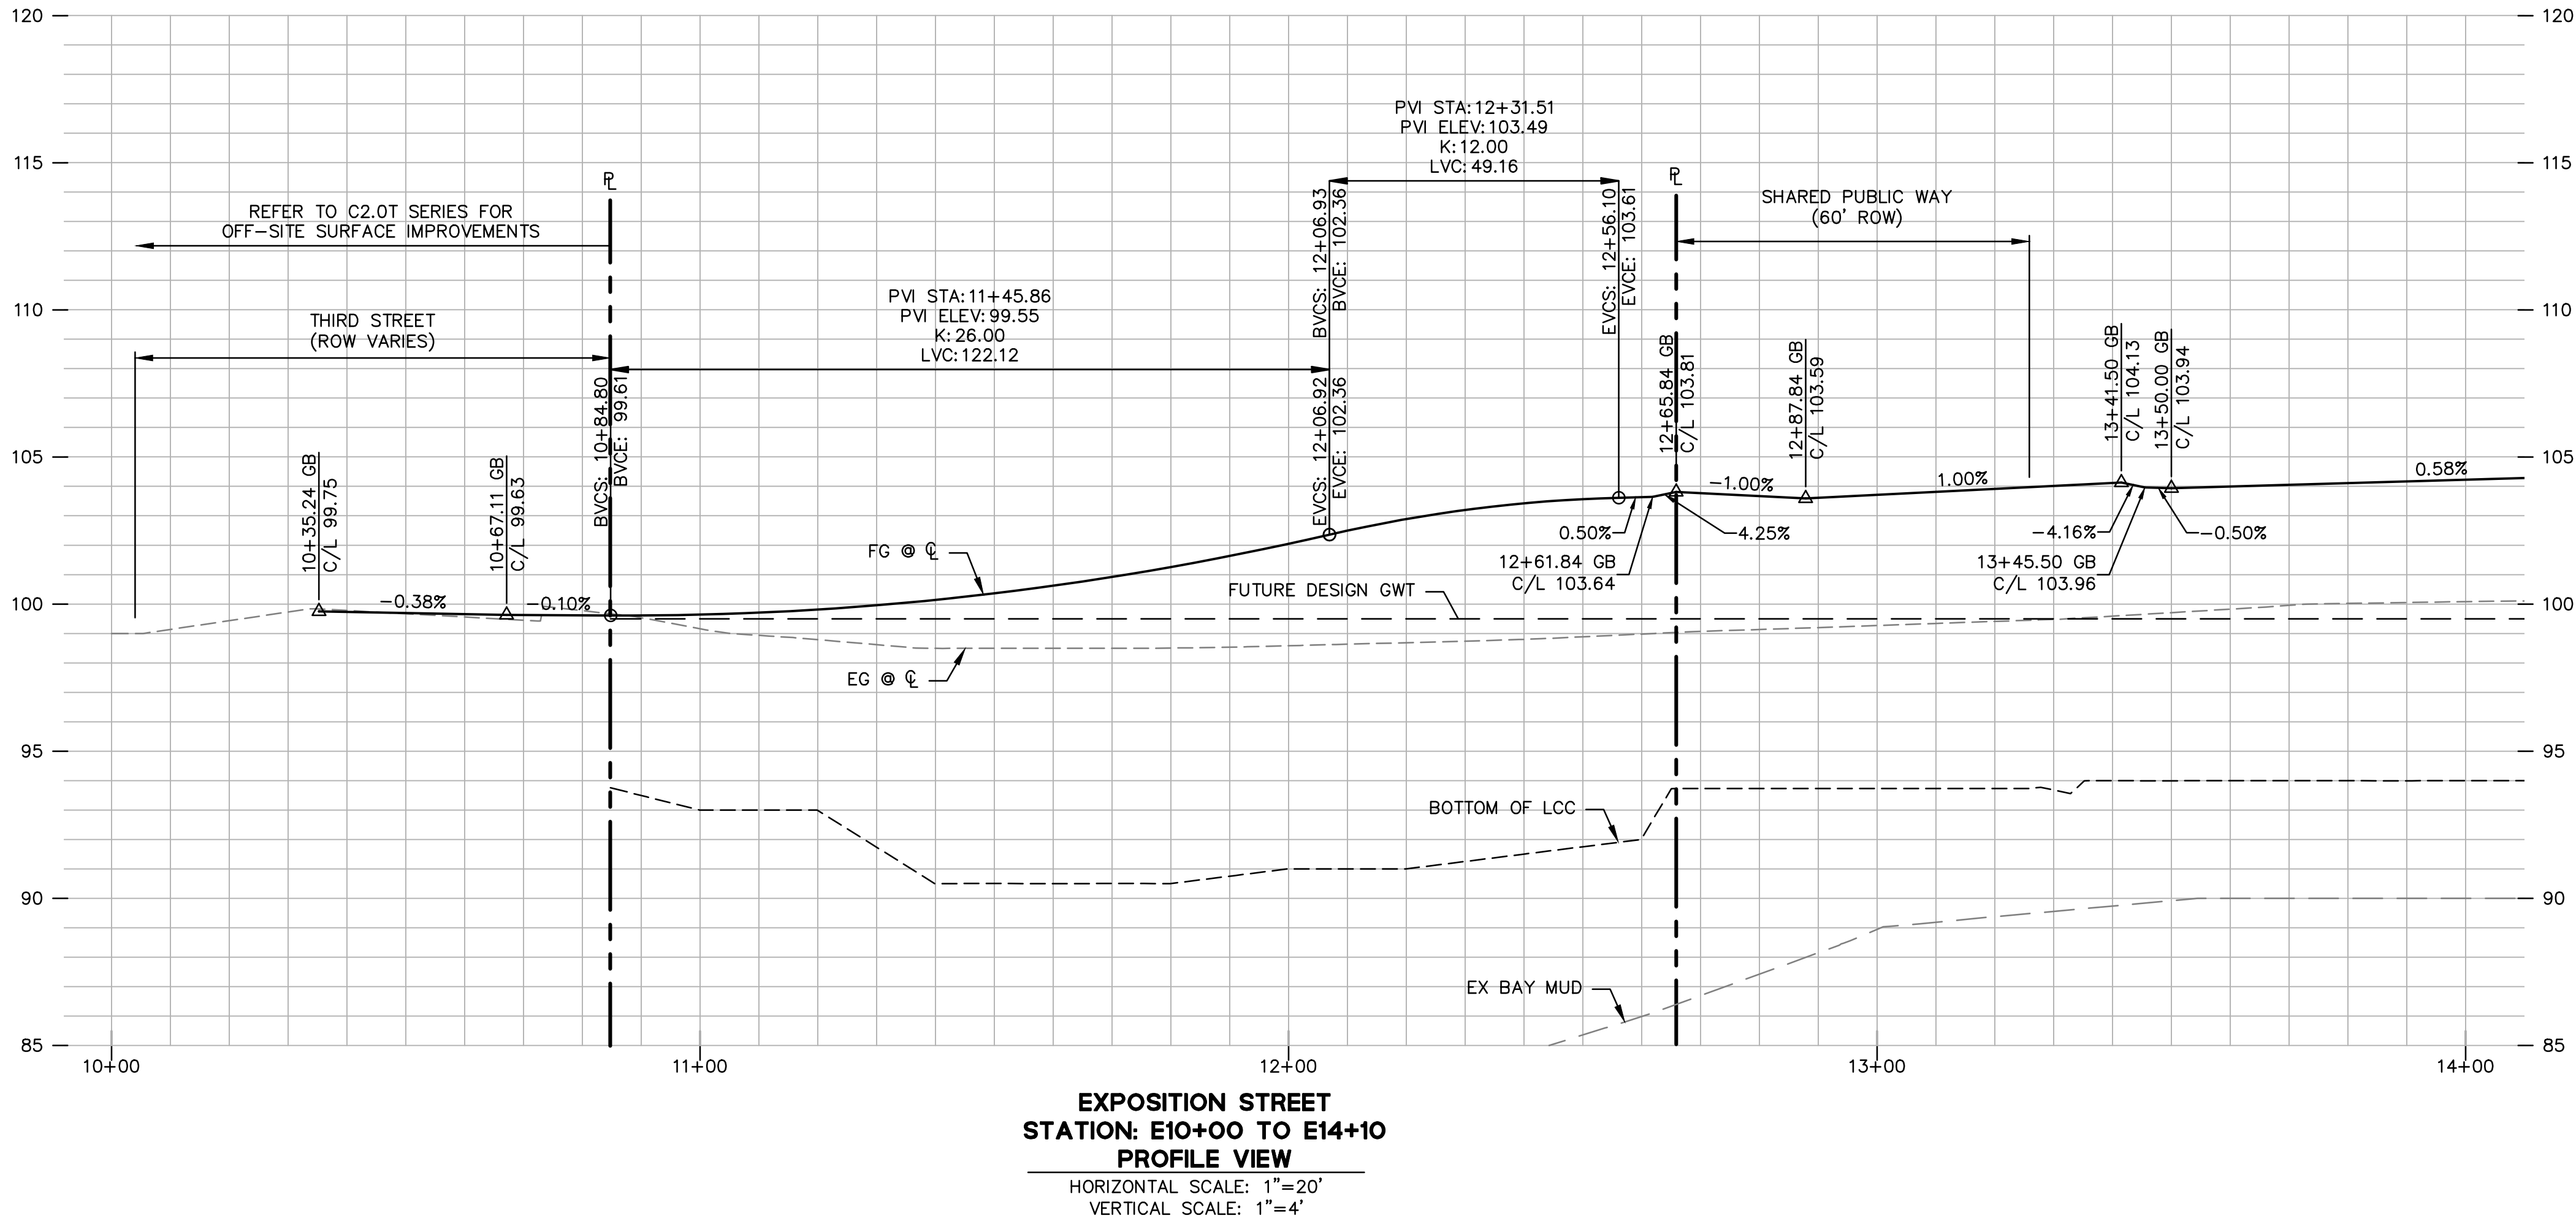


- GRADING NOTES**
1. ALL STATIONS AND OFFSETS SHOWN ON THIS STREET ARE REFERENCED FROM THE CENTERLINE ALIGNMENT.
 2. SEE SHEETS C6.07 THROUGH C6.11 FOR DETAILED GRADING AT ACCESSIBLE CURB RAMPS AND CROSSWALKS.
 3. FOR TYPICAL ROAD SECTIONS, SEE SHEETS C8.00 THROUGH C8.02.
 4. REFER TO GRADES SHOWN ON THE OFF-SITE THIRD STREET PLANS.
 5. CONTRACTOR TO PROVIDE FENCE OR CONCRETE FALL PROTECTION ADJACENT TO DEVELOPMENT PARCELS.
 6. SEE STORMWATER TREATMENT SHEETS C12.00 THROUGH C12.04 FOR ADDITIONAL GRADING INFORMATION.
 7. ALL LIGHTWEIGHT CELLULAR CONCRETE (LCC) INFORMATION SHOWN WILL BE DESIGNED AND PROVIDED BY THE GEOTECHNICAL ENGINEER.

MISSION ROCK PHASE 1
STREET IMPROVEMENT PLANS
GRADING PLAN - EXPOSITION STREET

Revisions		No.	
STREET IMPROVEMENT PLANS - PHASE 1		No.	
Scale AS SHOWN		Design JW	
Drawn KCC/JM		Approved JD	
Drawing Number:		Job No 20080006	
Date 6/17/2019		C6.01	
56 OF 283		FIRST SUBMITTAL - NOT FOR CONSTRUCTION	

SAN FRANCISCO COUNTY
SAN FRANCISCO
CALIFORNIA

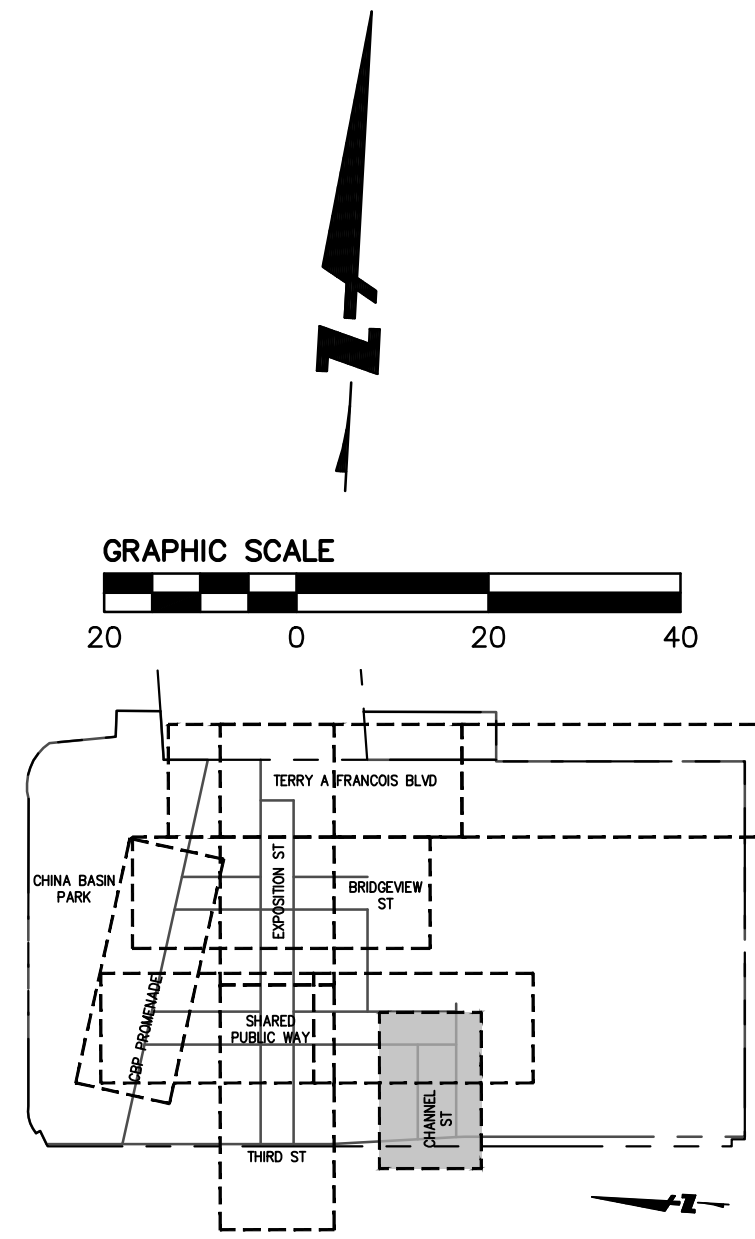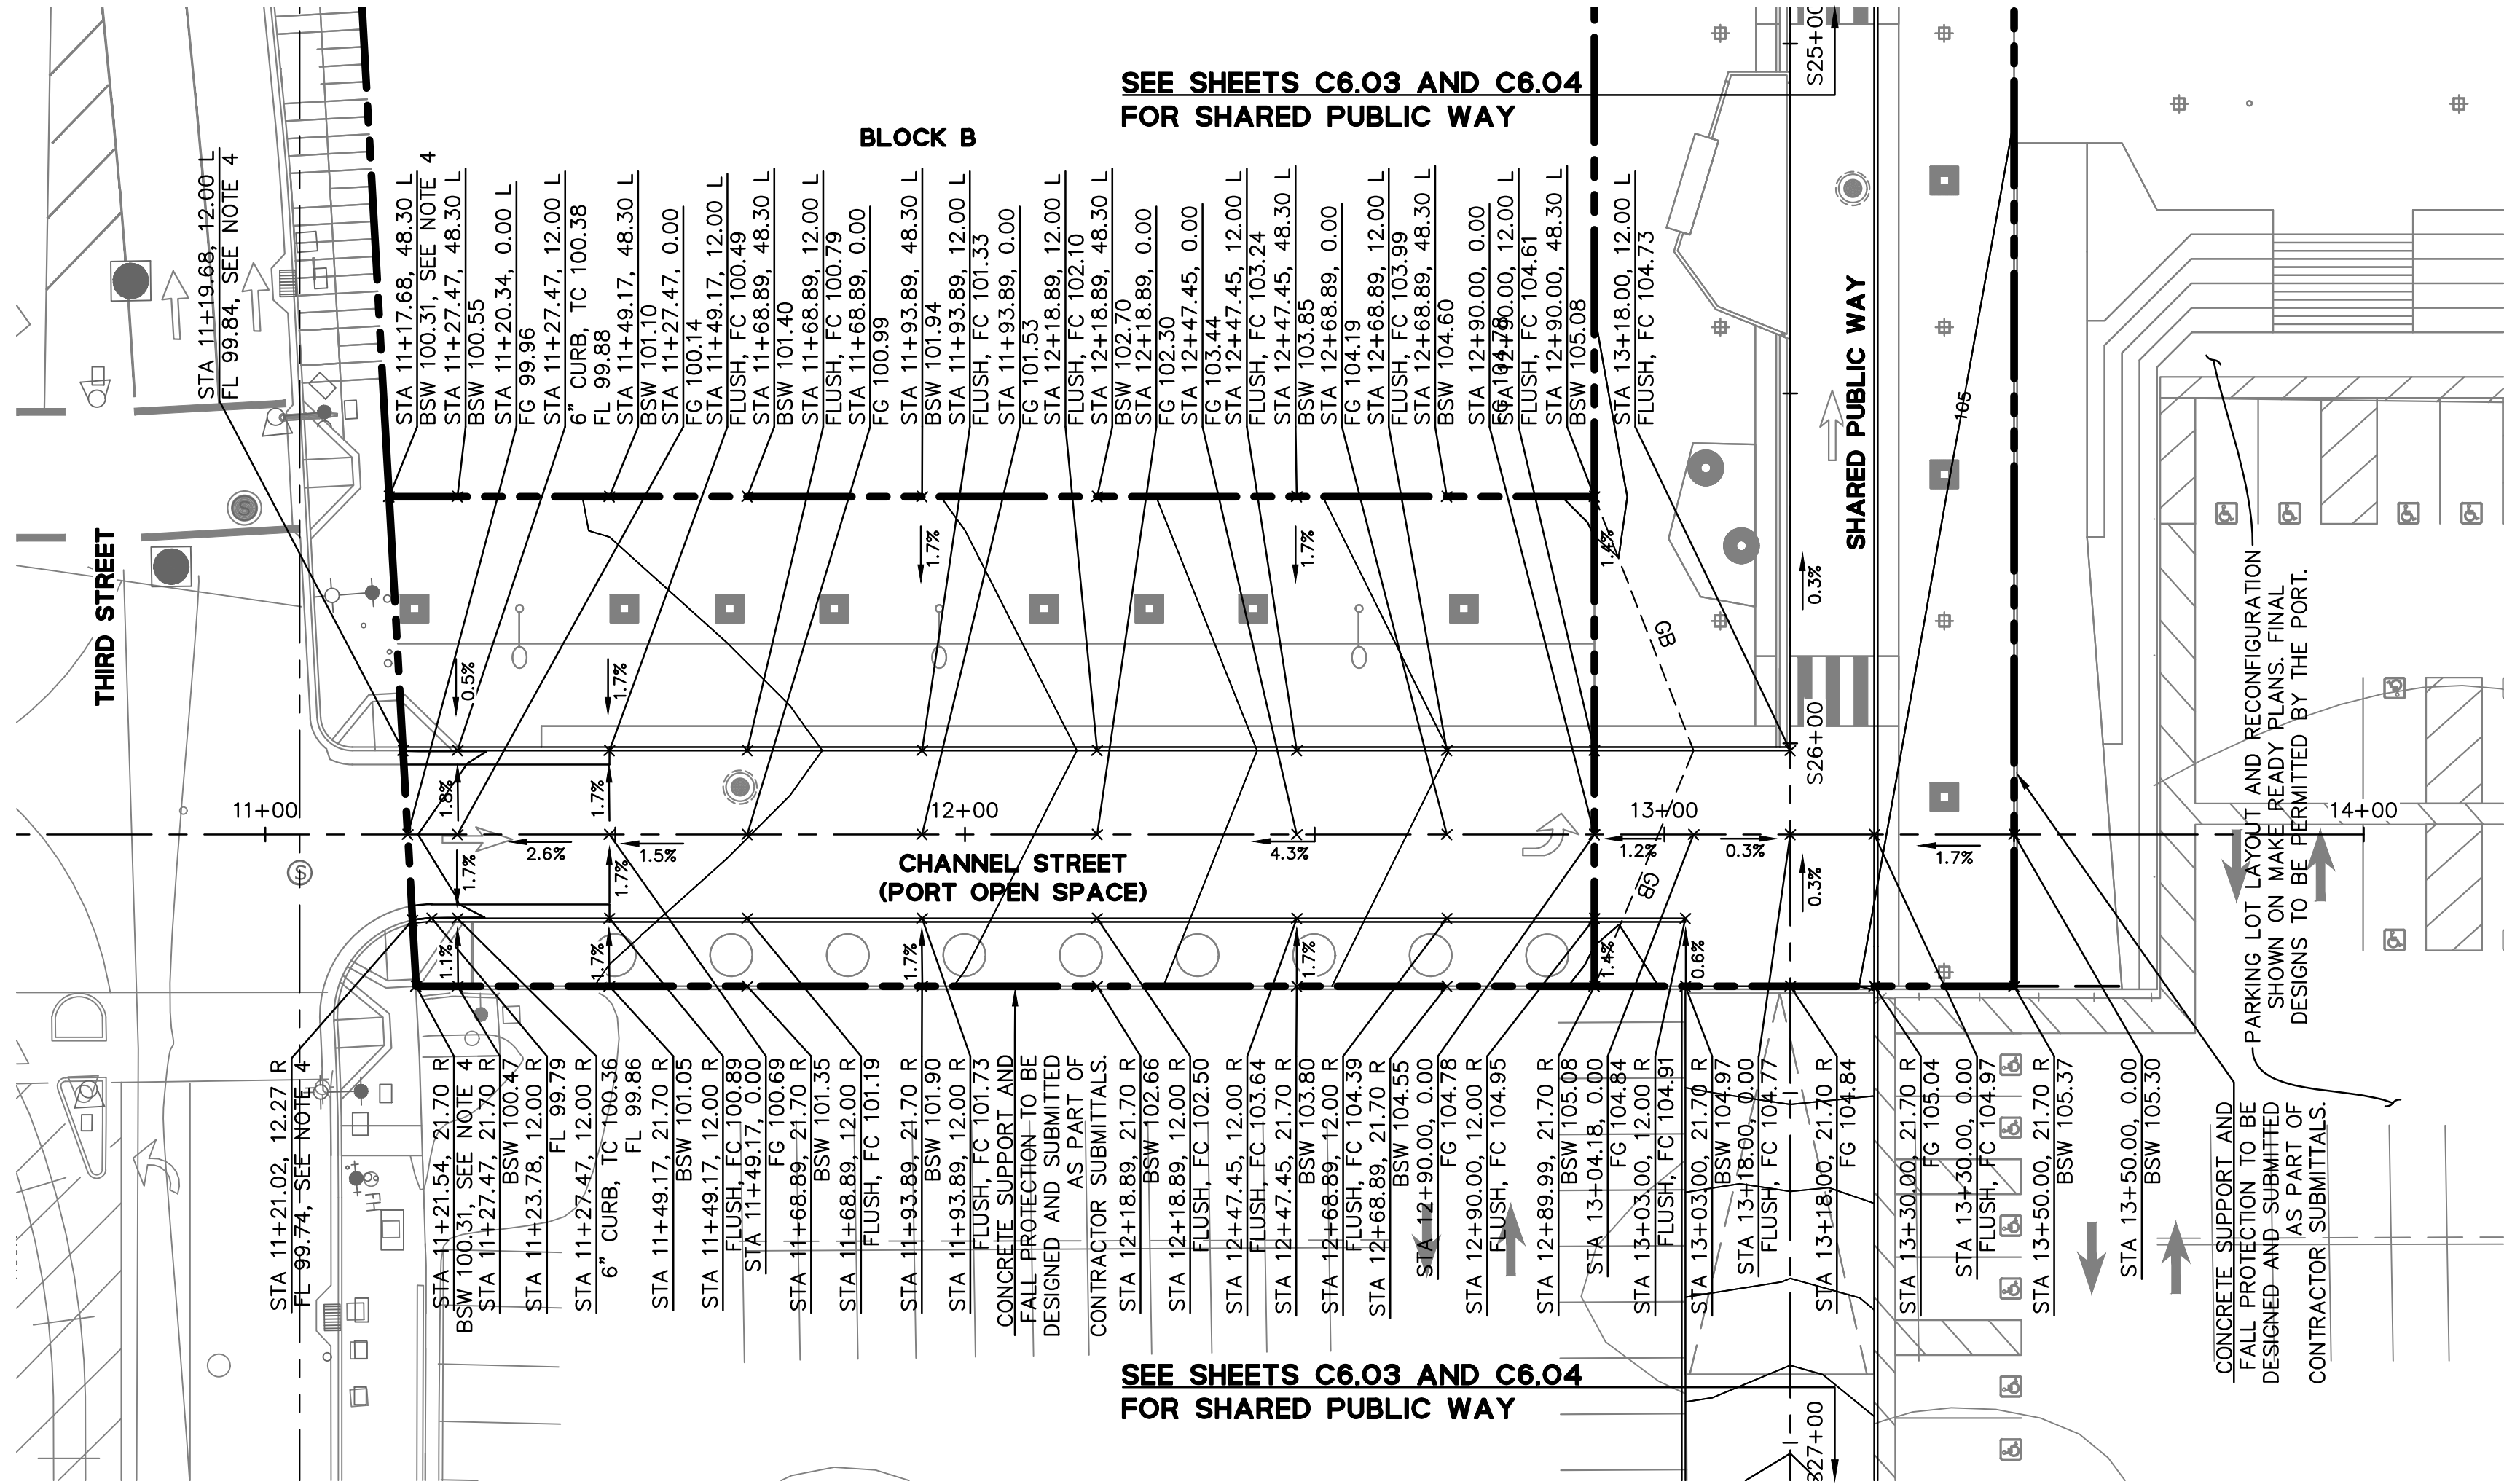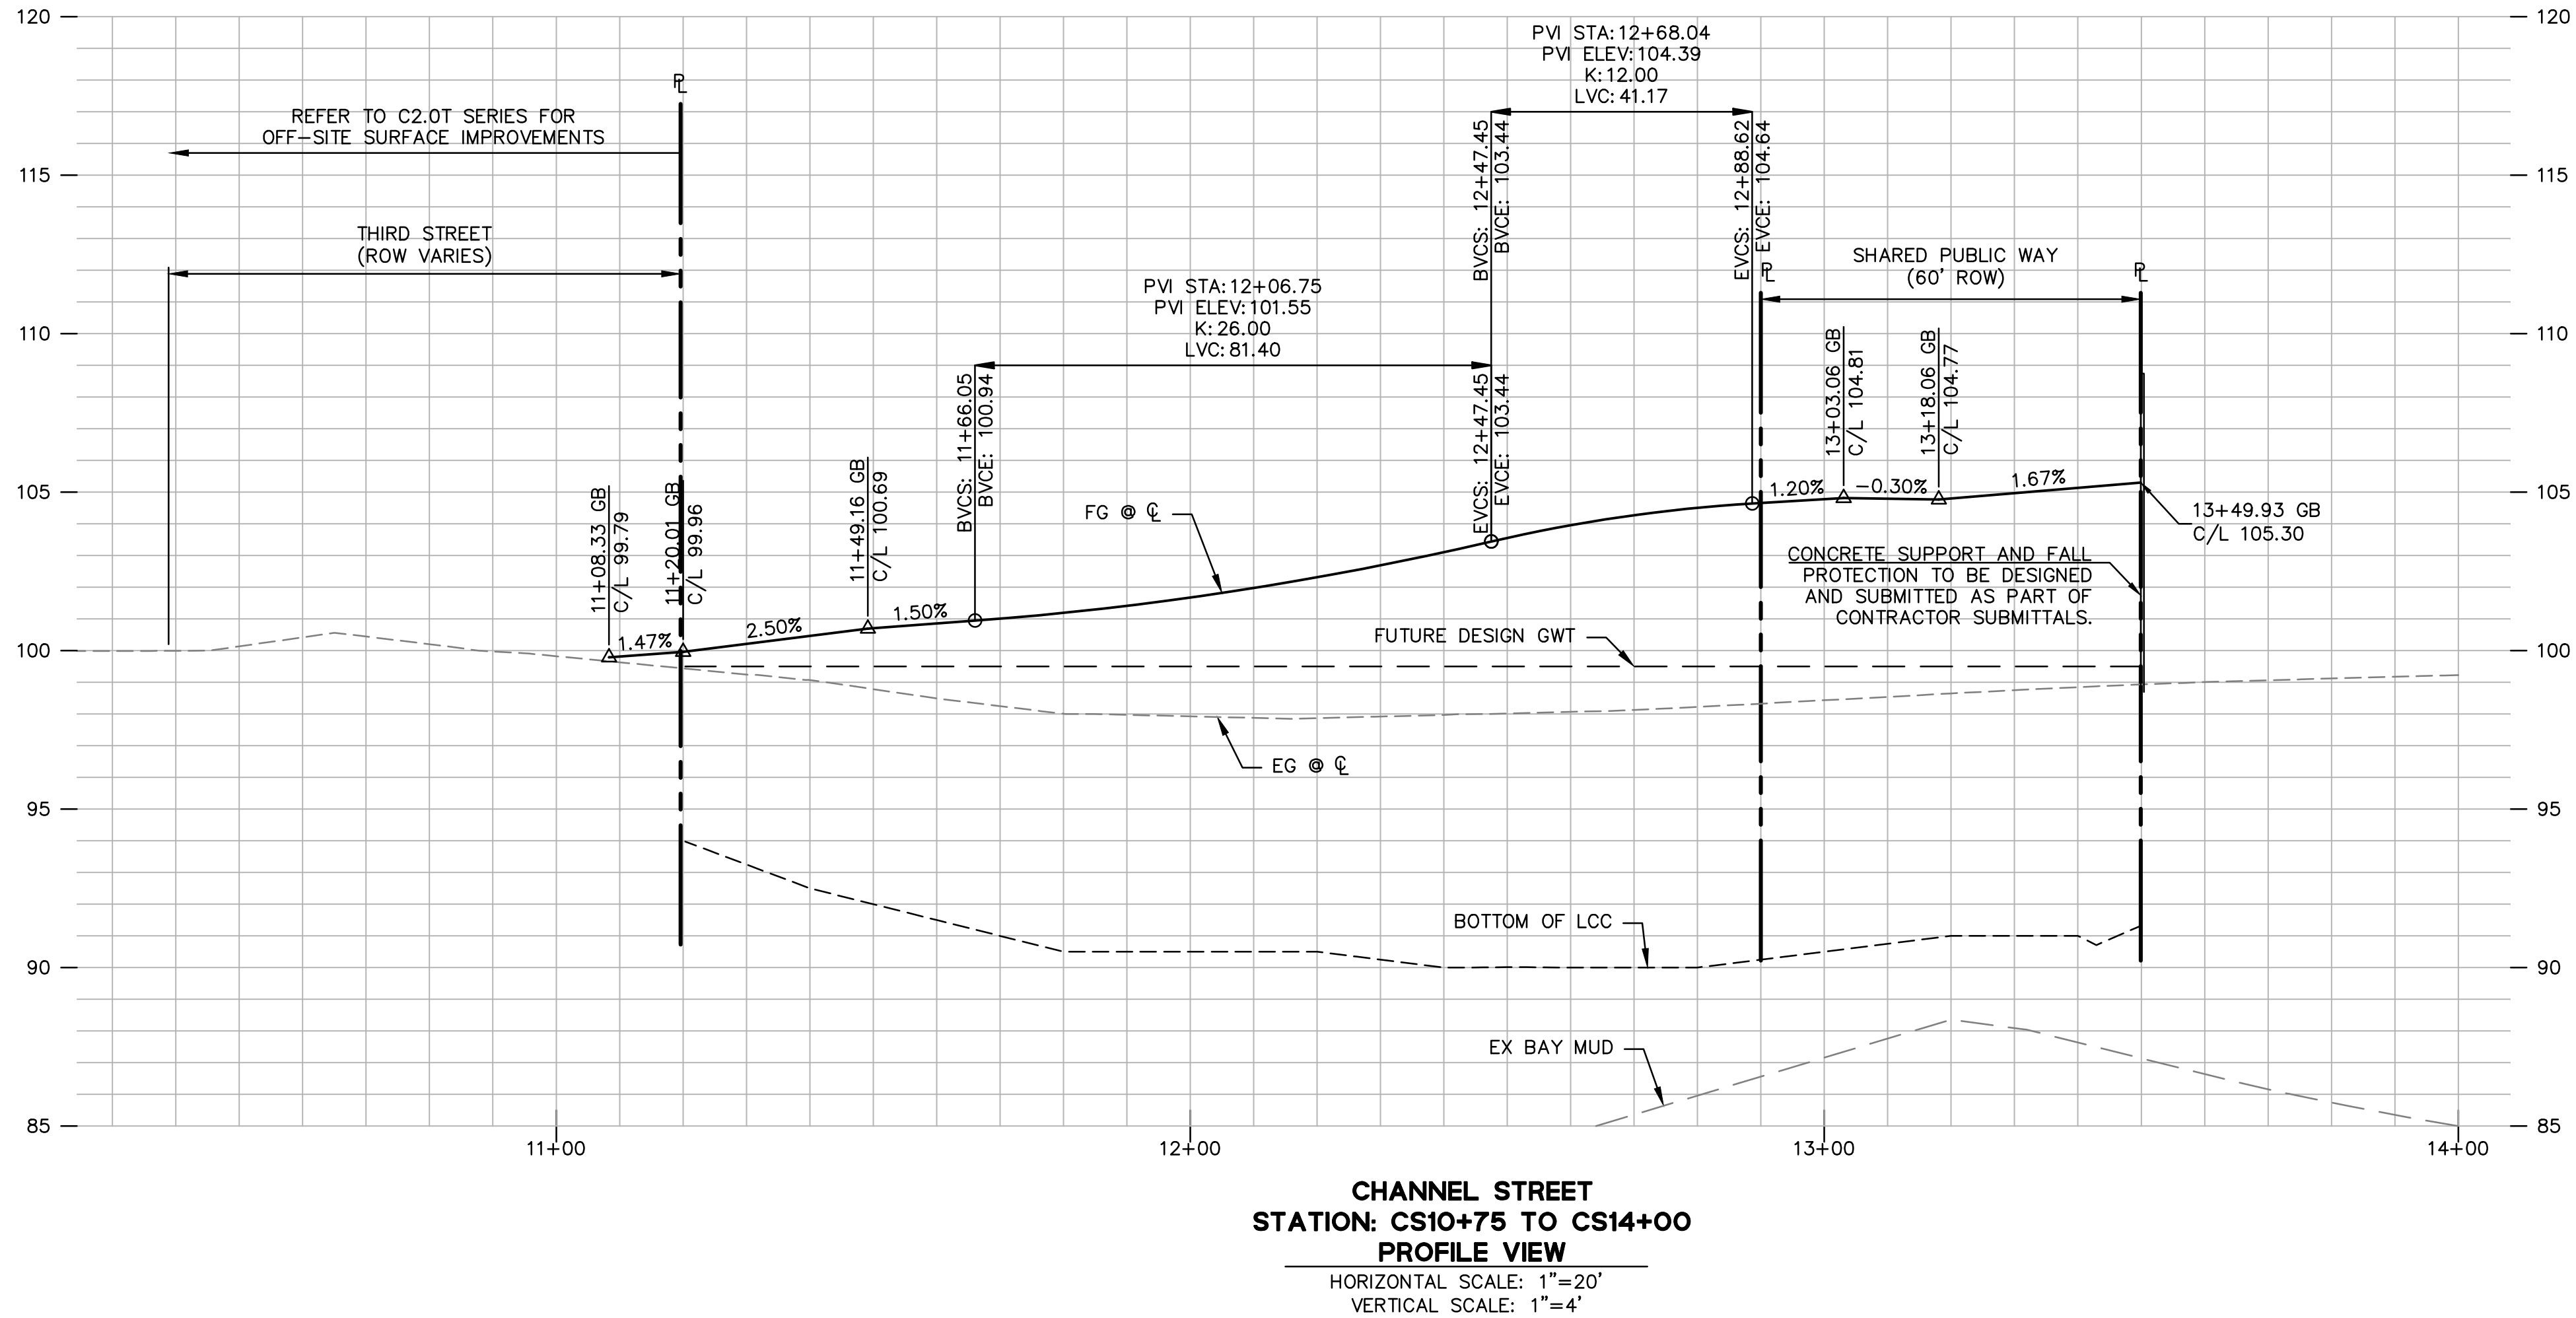

- GRADING NOTES**
1. ALL STATIONS AND OFFSETS SHOWN ON THIS STREET ARE REFERENCED FROM THE CENTERLINE ALIGNMENT.
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Date	No.	Revisions
6/17/2019		STREET IMPROVEMENT PLANS - PHASE 1
Scale AS SHOWN	JW	
Design	KCC/JM	
Drawn	KCC/JM	
Approved	JD	
Job No 20080006		
Drawing Number:		

MISSION ROCK PHASE 1
STREET IMPROVEMENT PLANS
GRADING PLAN - CHANNEL STREET

SAN FRANCISCO

SAN FRANCISCO COUNTY

CALIFORNIA

Revisions
 PLANS – PHASE 1


Date	No.	Revisions
6/17/2019		
Scale AS SHOWN		STREET IMPROVEMENT PLANS -- PHASE 1
Design JW		
Drawn KCC/JM		
Approved JD		
Job No 20080006		

Drawing Number:


C6.03

58 OF 283

1. ALL STATIONS AND OFFSETS SHOWN ON THIS STREET ARE REFERENCED FROM THE CENTERLINE ALIGNMENT.
2. SEE SHEETS C6.07 THROUGH C6.11 FOR DETAILED GRADING AT ACCESSIBLE CURB RAMPS AND CROSSWALKS.
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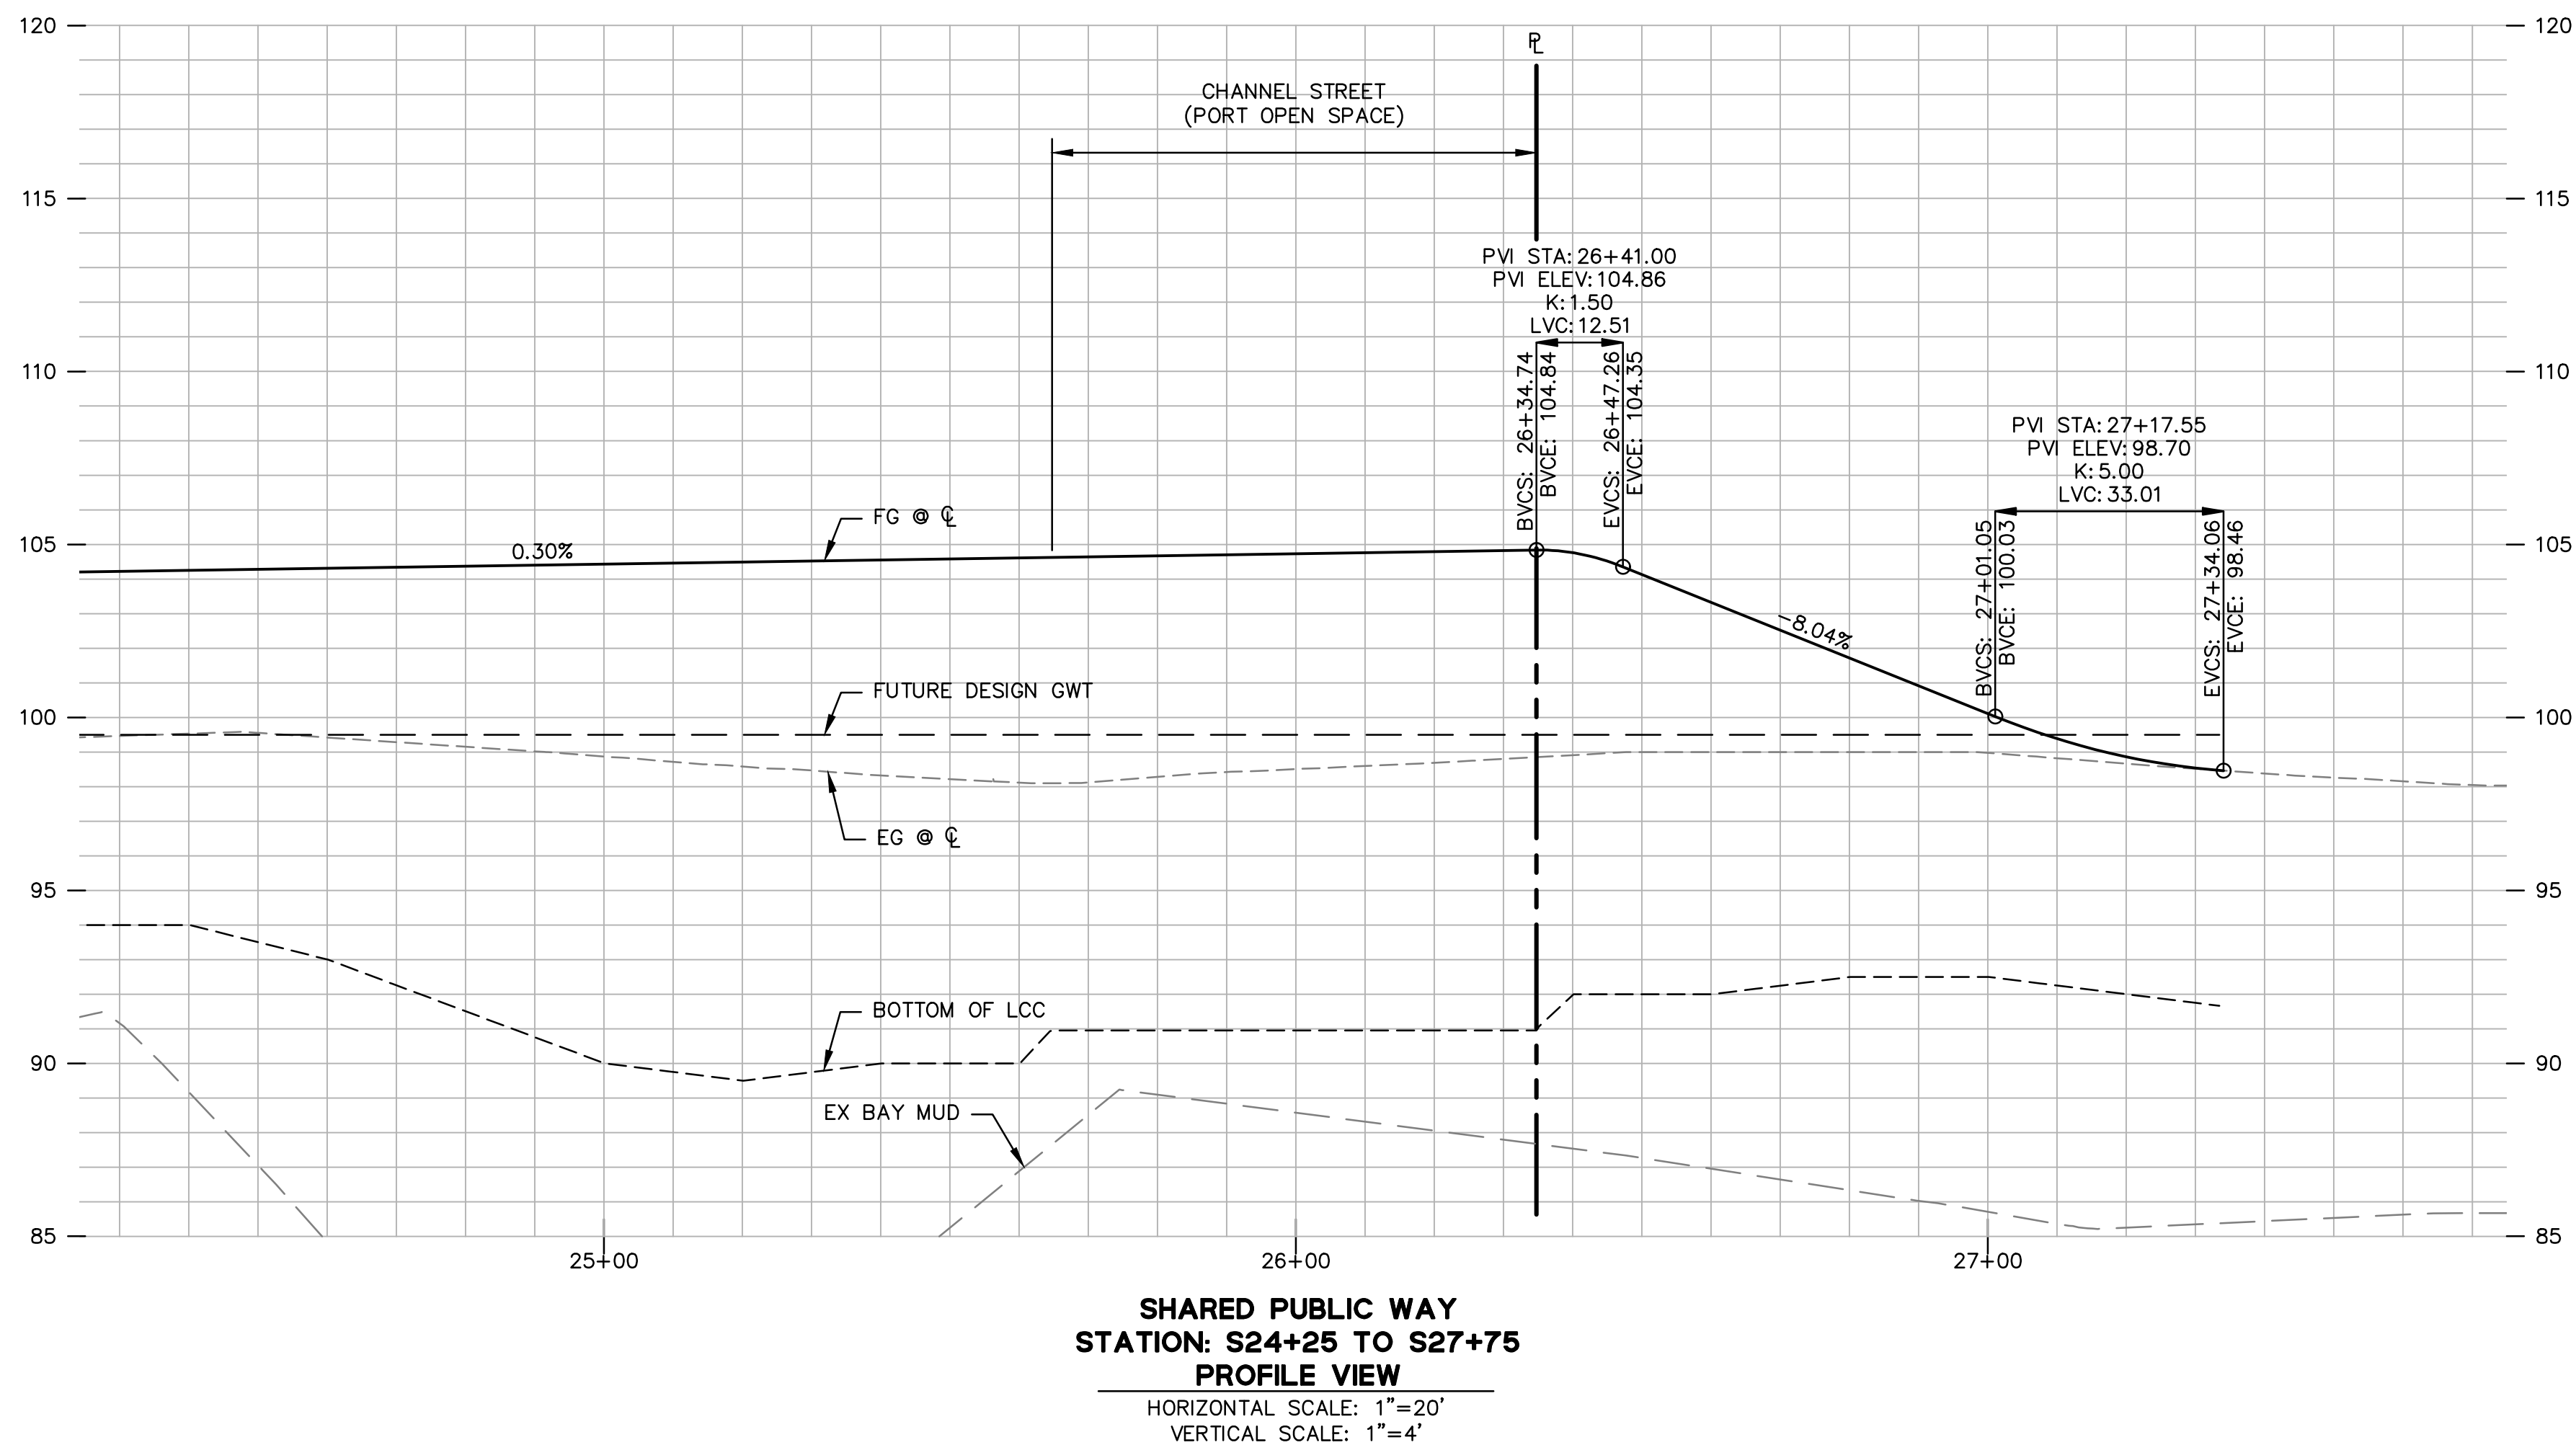
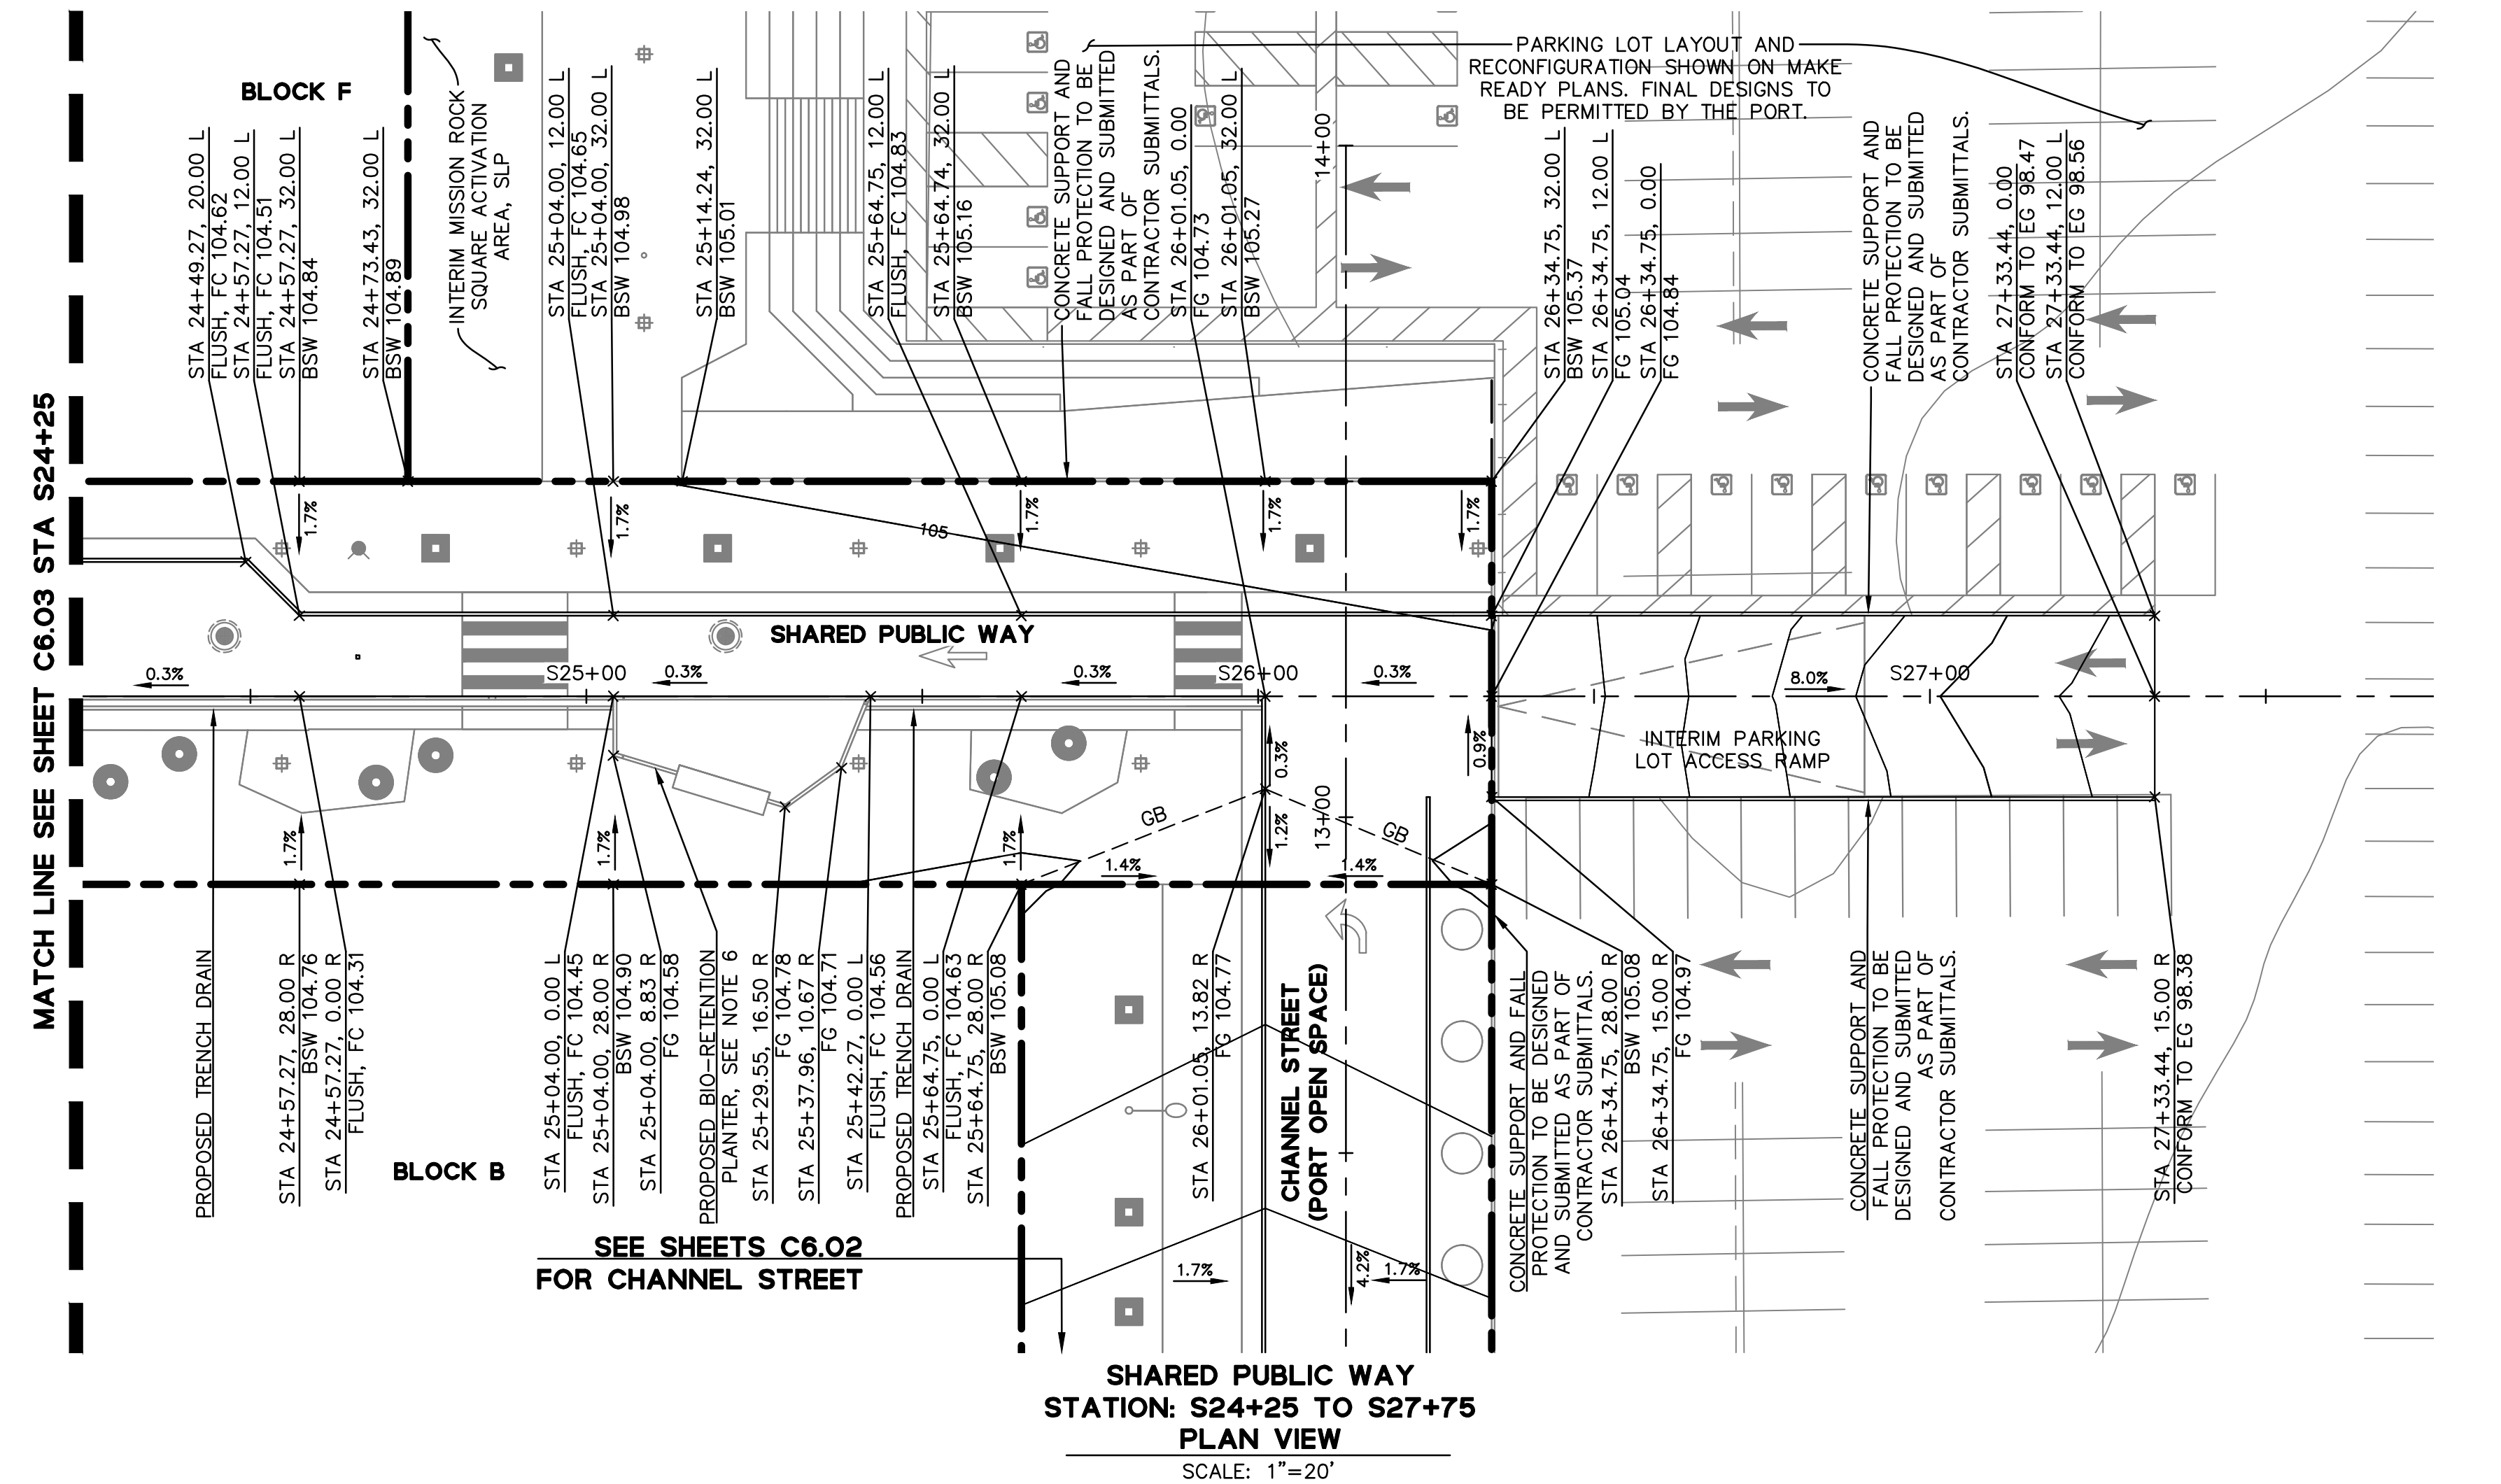
SHARED PUBLIC WAY
STATION: S20+00 TO S24+25
PLAN VIEW
SCALE: 1"=20'

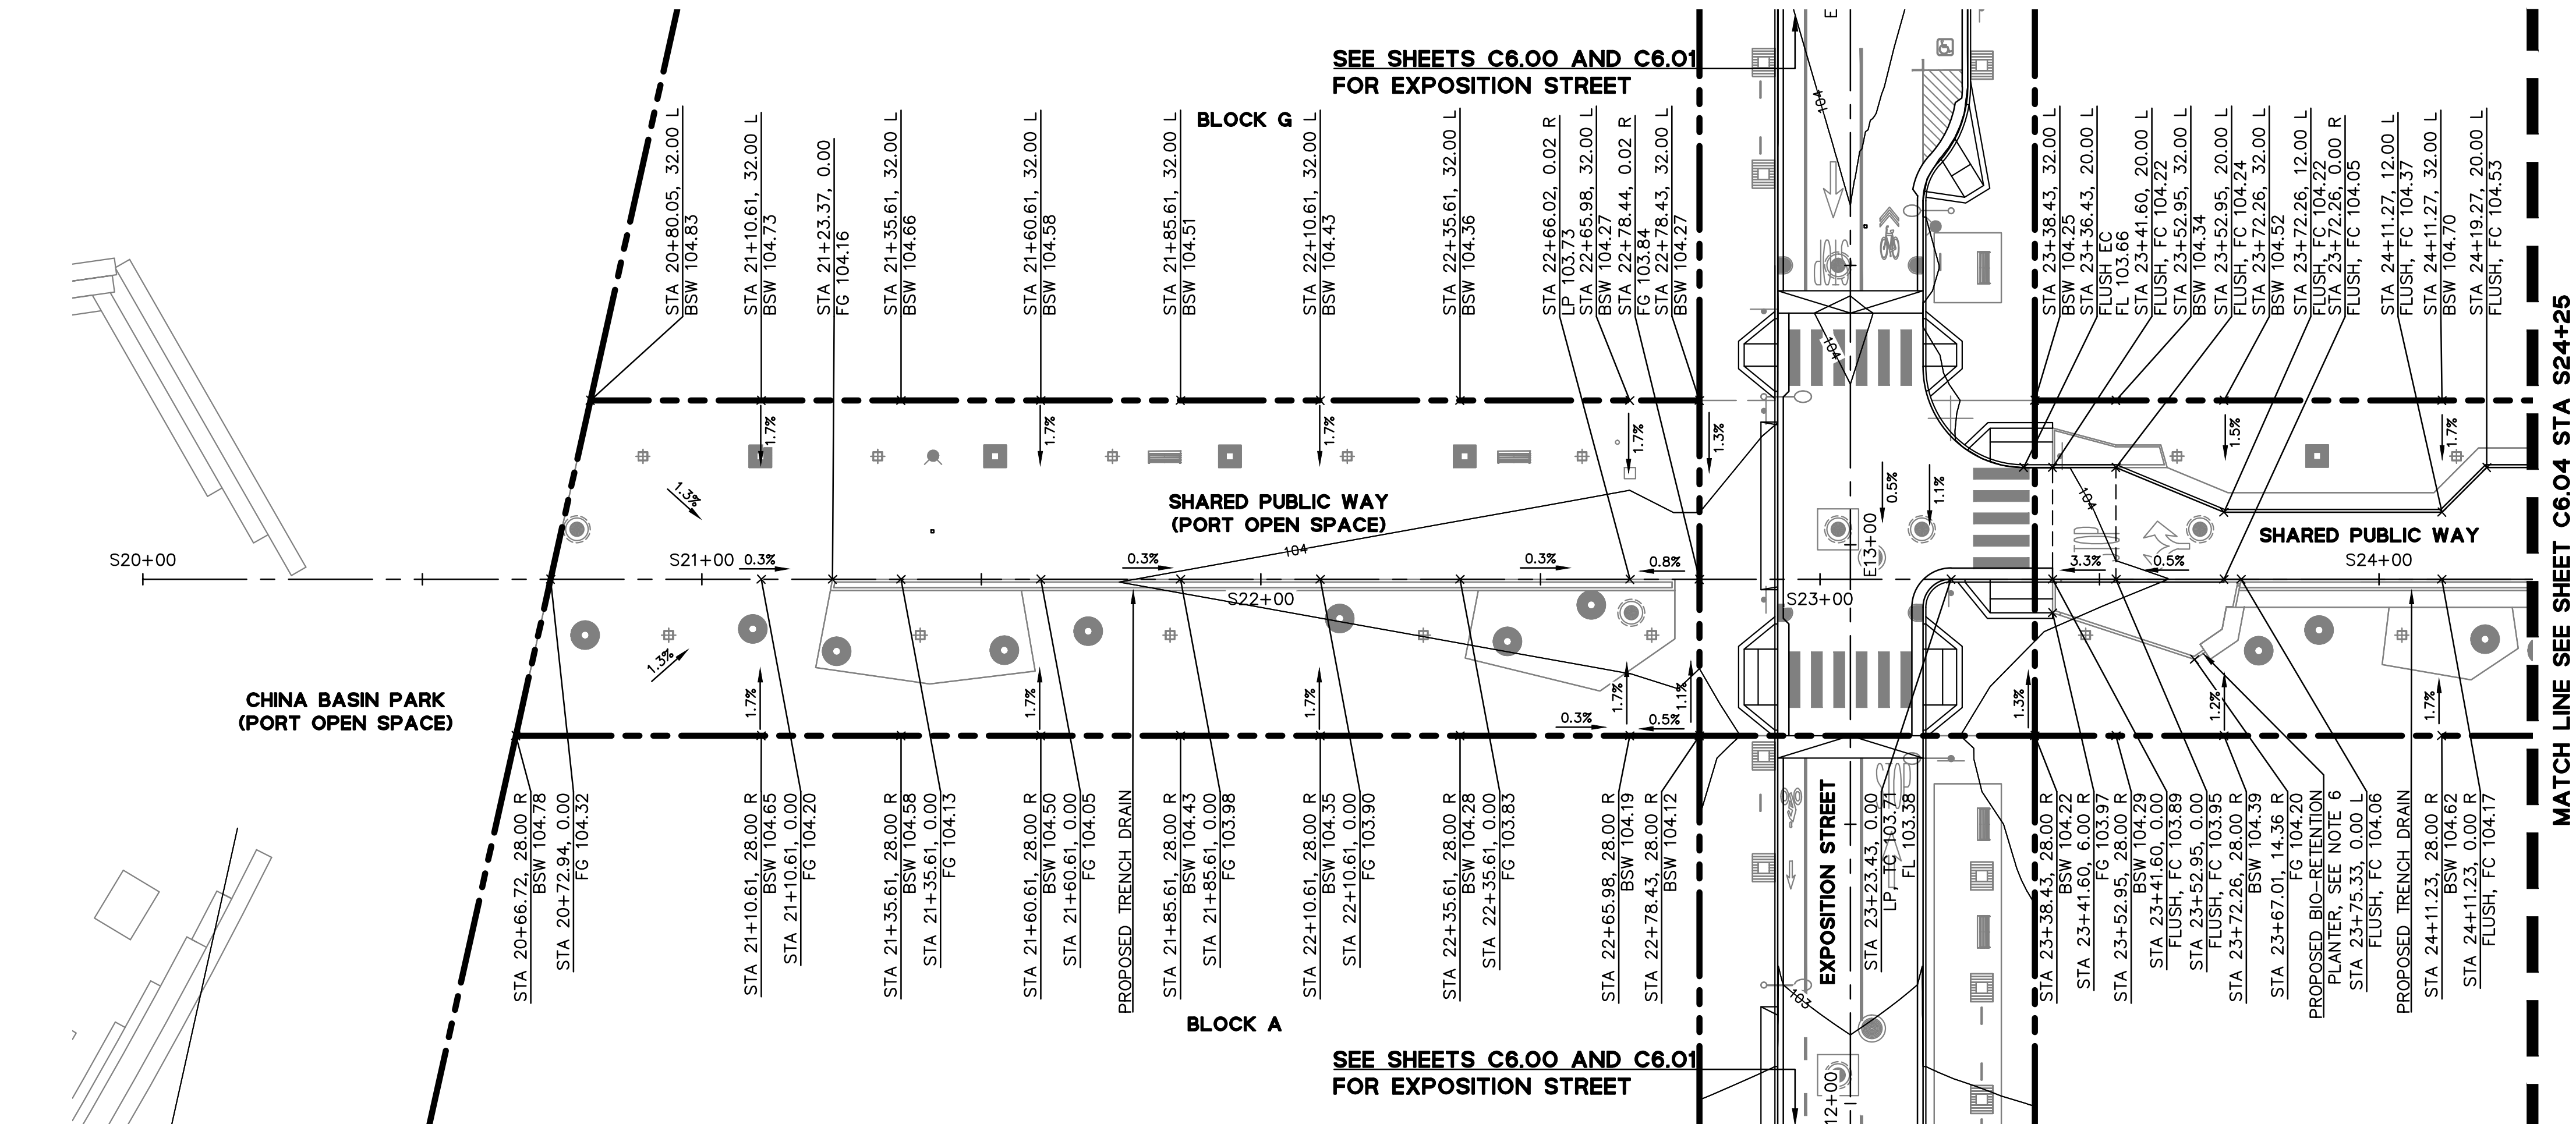

SHARED PUBLIC WAY
STATION: S20+00 TO S24+25
PROFILE VIEW

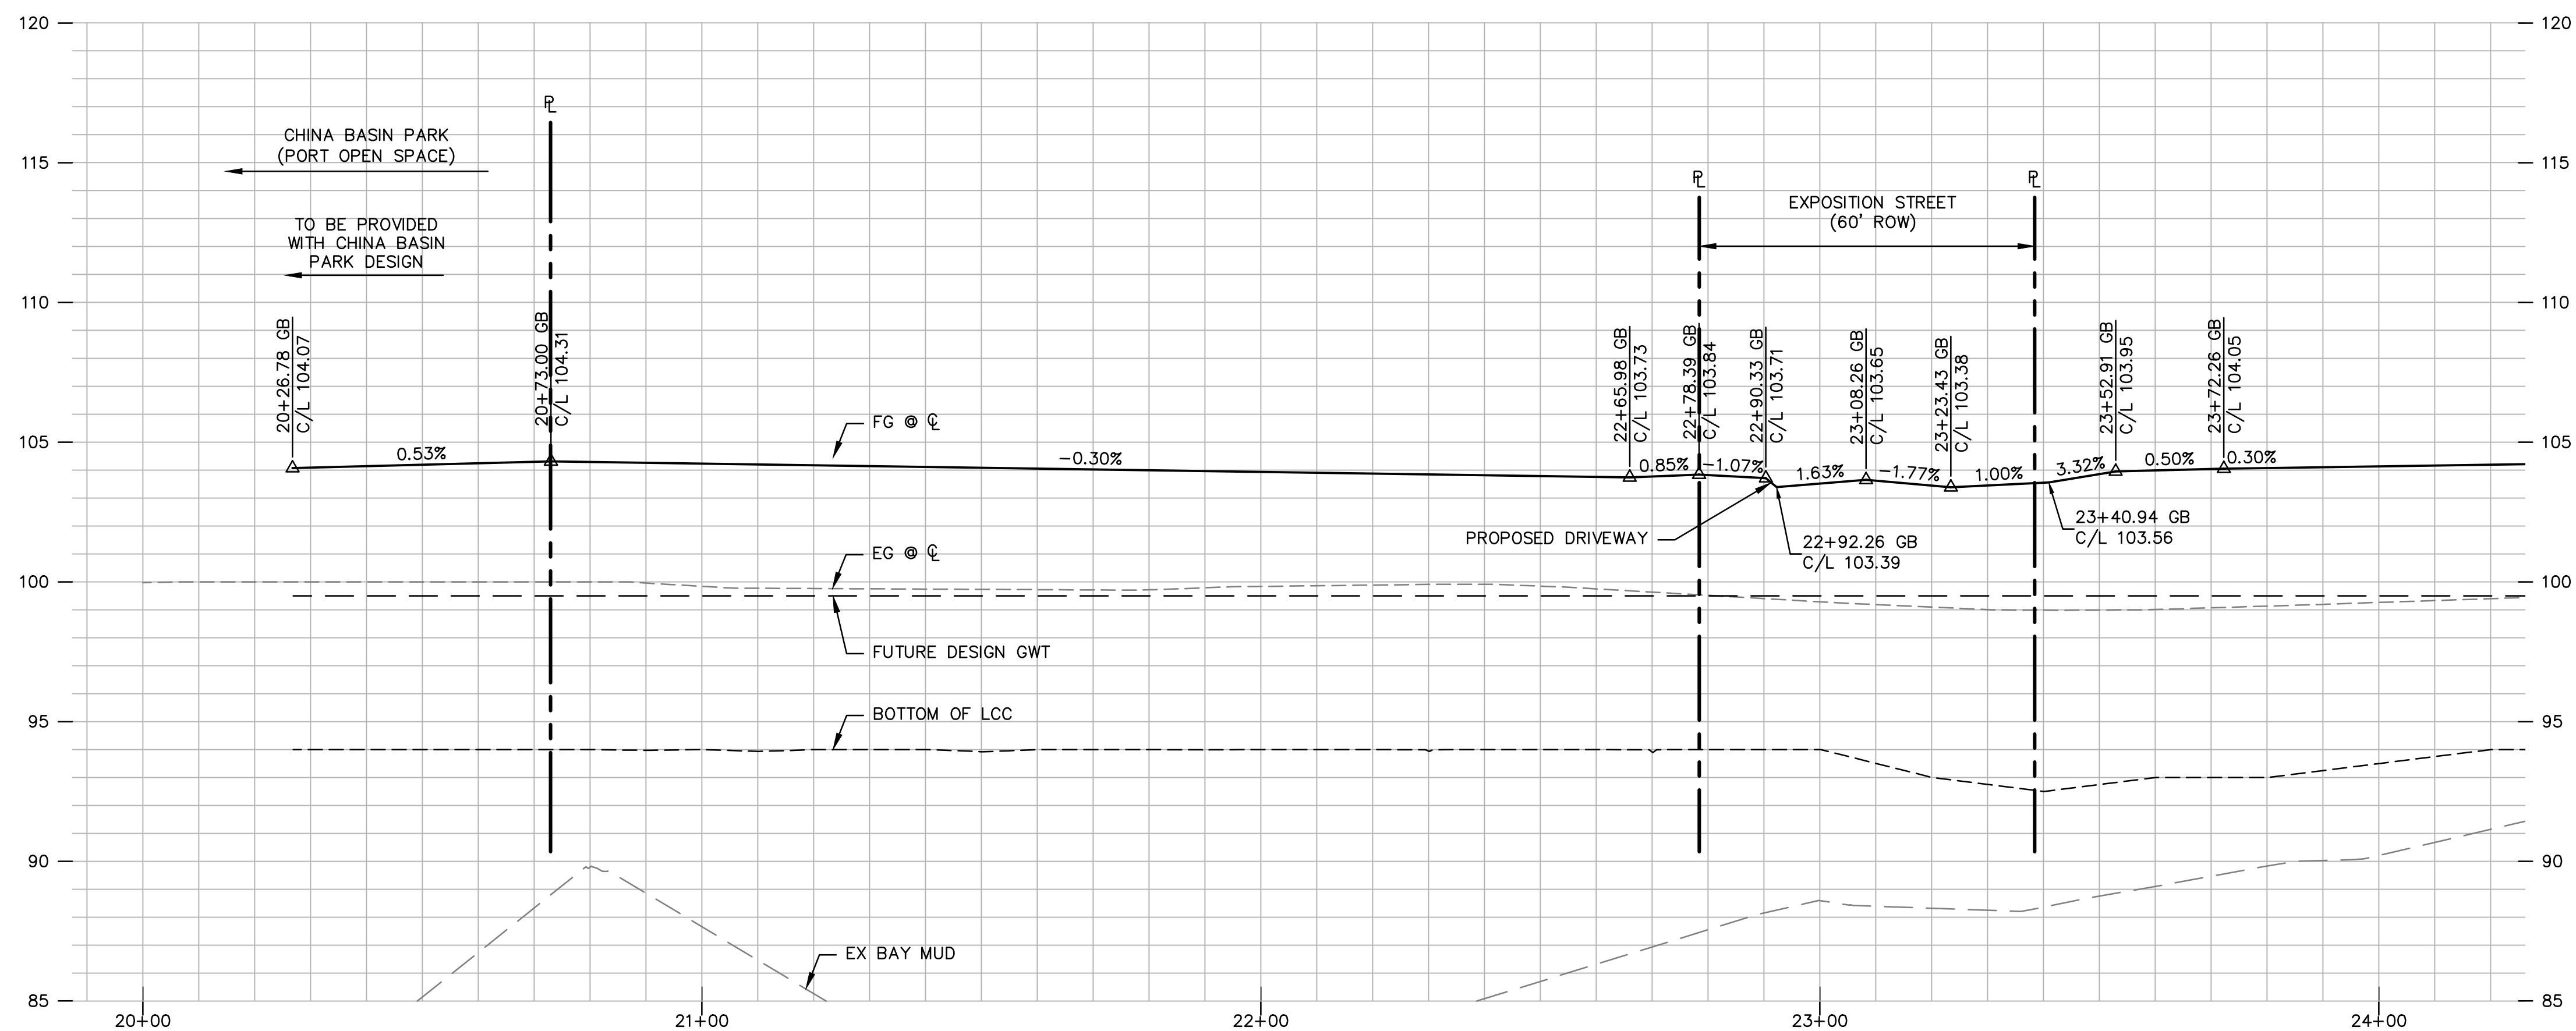HORIZONTAL SCALE: 1"=20'
VERTICAL SCALE: 1"=4'

DRAWING NAME: \\Bkf-sf\vol4_2008\080006_Mission Rock\ENG\SIP\PLOTED SHEETS\C6.00 - GRADING PLAN.dwg
PLOT DATE: 06-16-19 PLOTTED BY: meyj



GRADING NOTES

1. ALL STATIONS AND OFFSETS SHOWN ON THIS STREET ARE REFERENCED FROM THE CENTERLINE ALIGNMENT.
2. SEE SHEETS C6.07 THROUGH C6.11 FOR DETAILED GRADING AT ACCESSIBLE CURB RAMPS AND CROSSWALKS.
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**MISSION ROCK PHASE 1
STREET IMPROVEMENT PLANS
GRADING PLAN – SHARED PUBLIC WAY**


SAN FRANCISCO COUNTY SAN FRANCISCO COUNTY

Date	6/17/2019	No.	Revisions
Design	AS SHOWN		
Scale	1/8"		
Drawn	KCC/JM		
Approved	JD		
Job No	20080006		



Drawing Number: **C6.04**

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FIRST SUBMITTAL - NOT FOR CONSTRUCTION

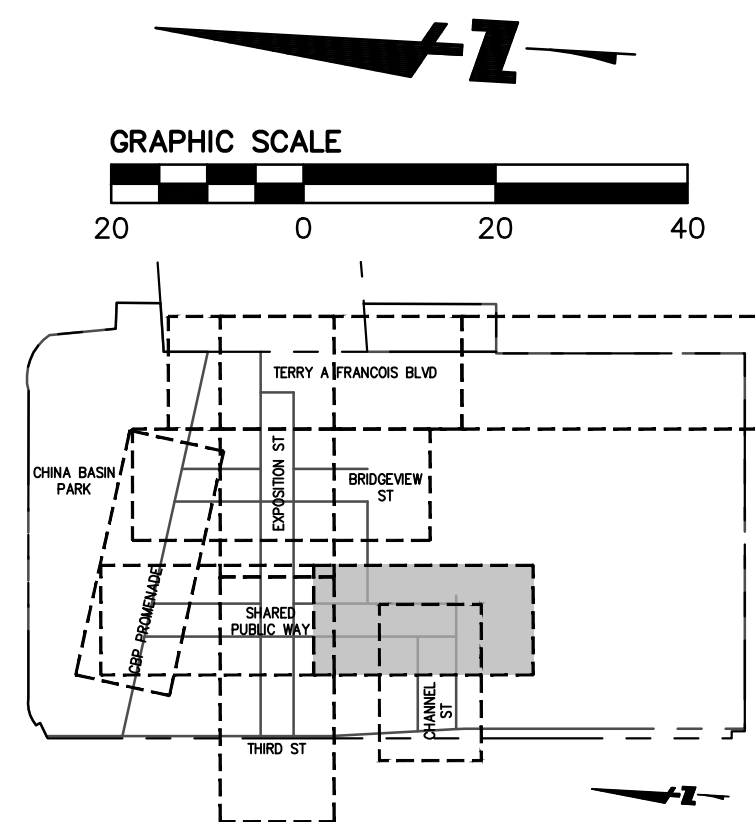


DRAWING NAME: \\Bkf-stf\vol4\2008\080006_Mission Rock\ENG\SIP\PLOTTED SHEETS\C6.00 - GRADING PLAN.dwg
PLOT DATE: 06-16-19 PLOTTED BY: meyj

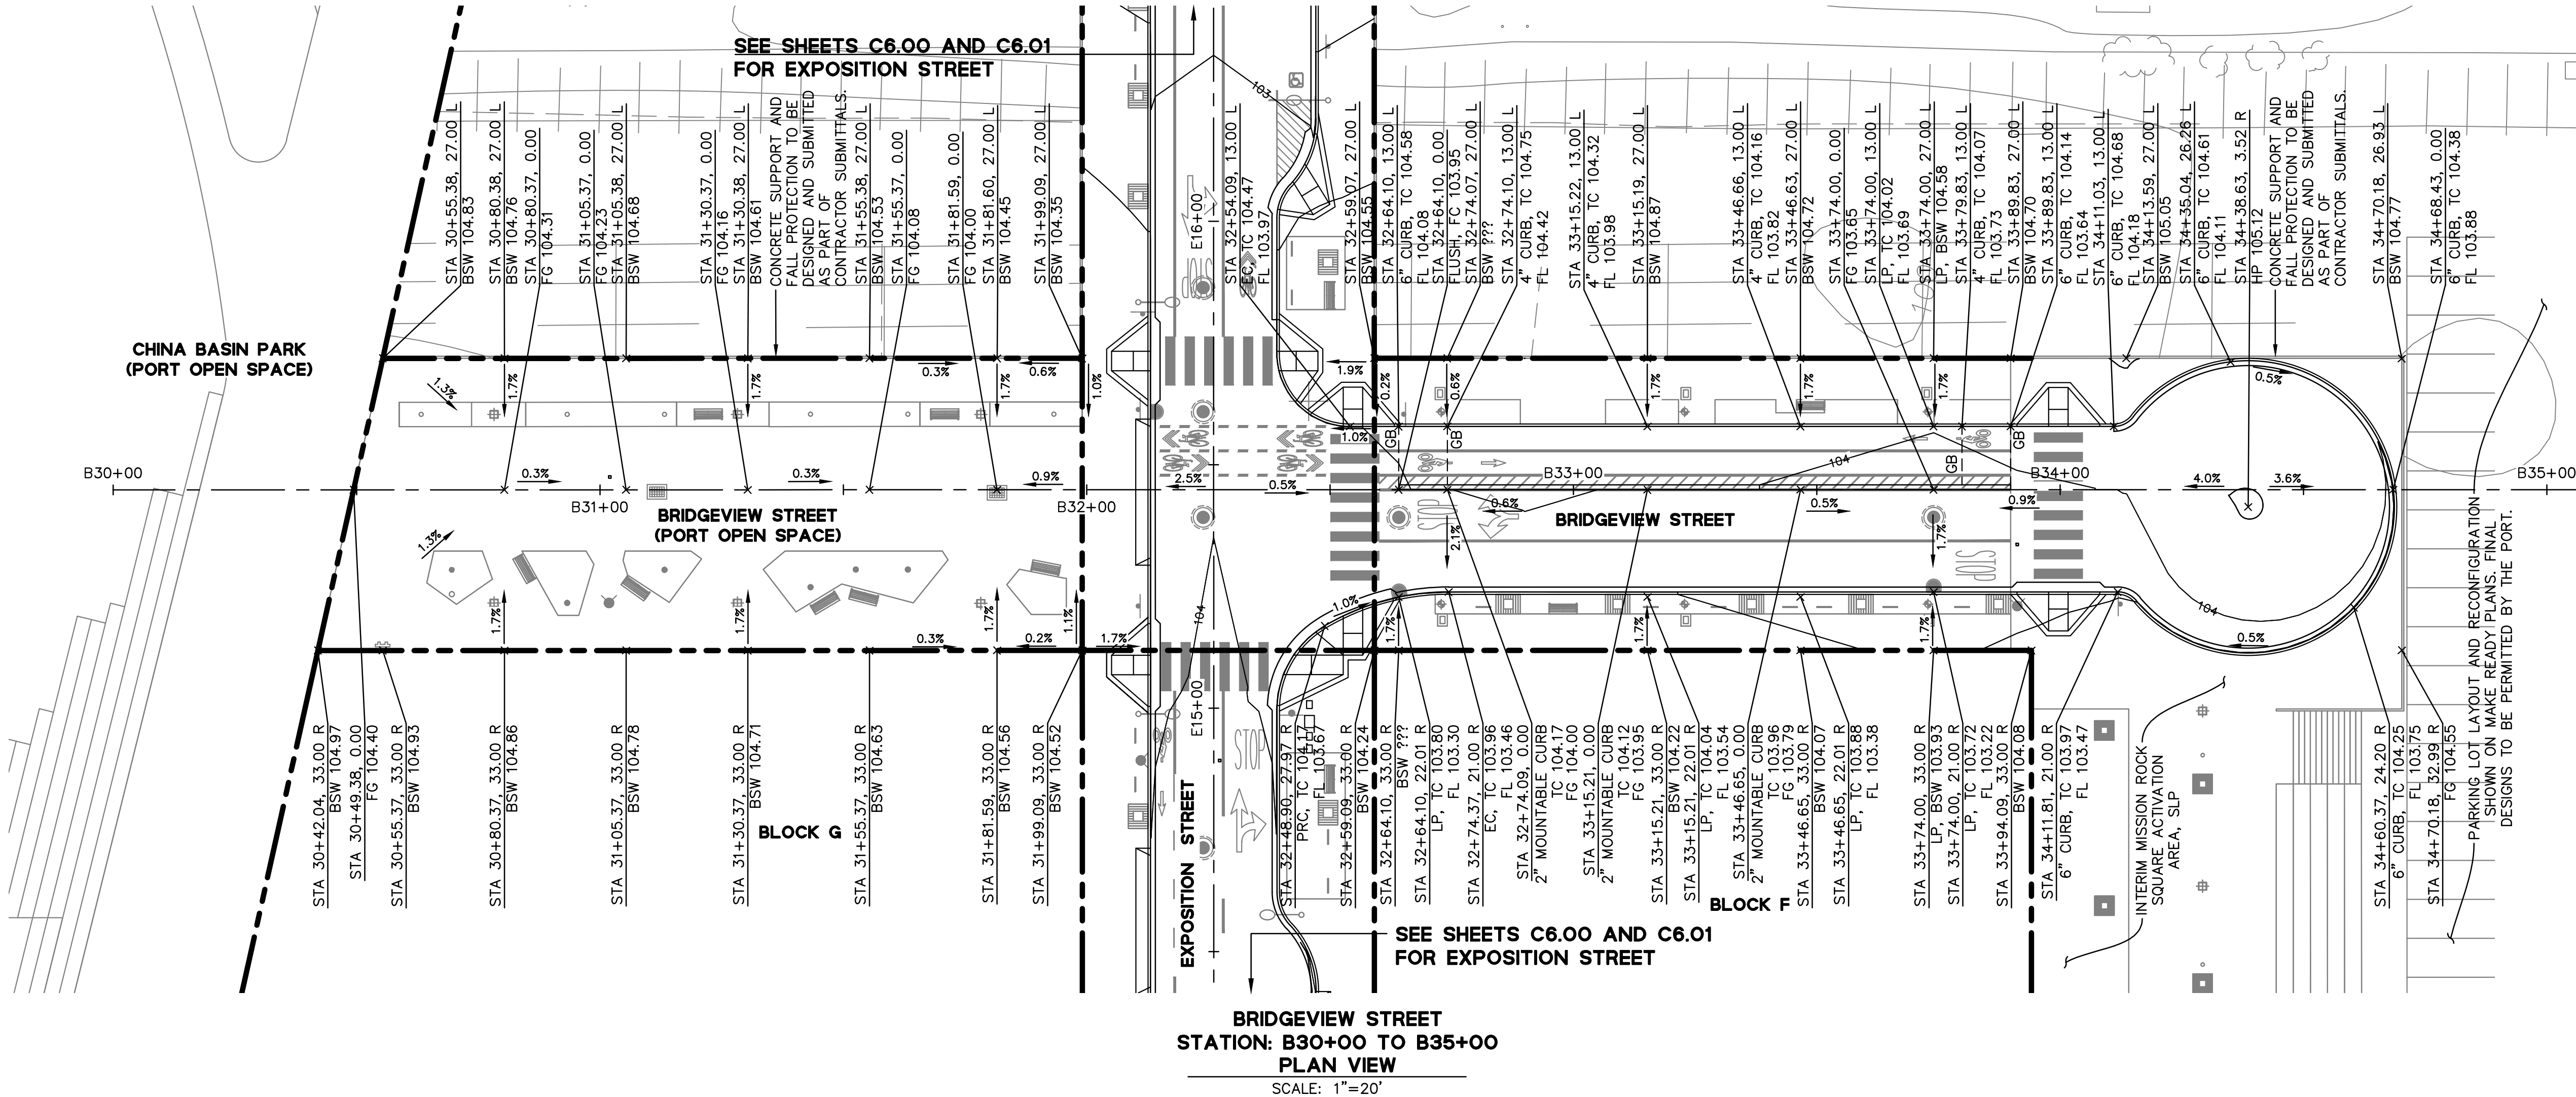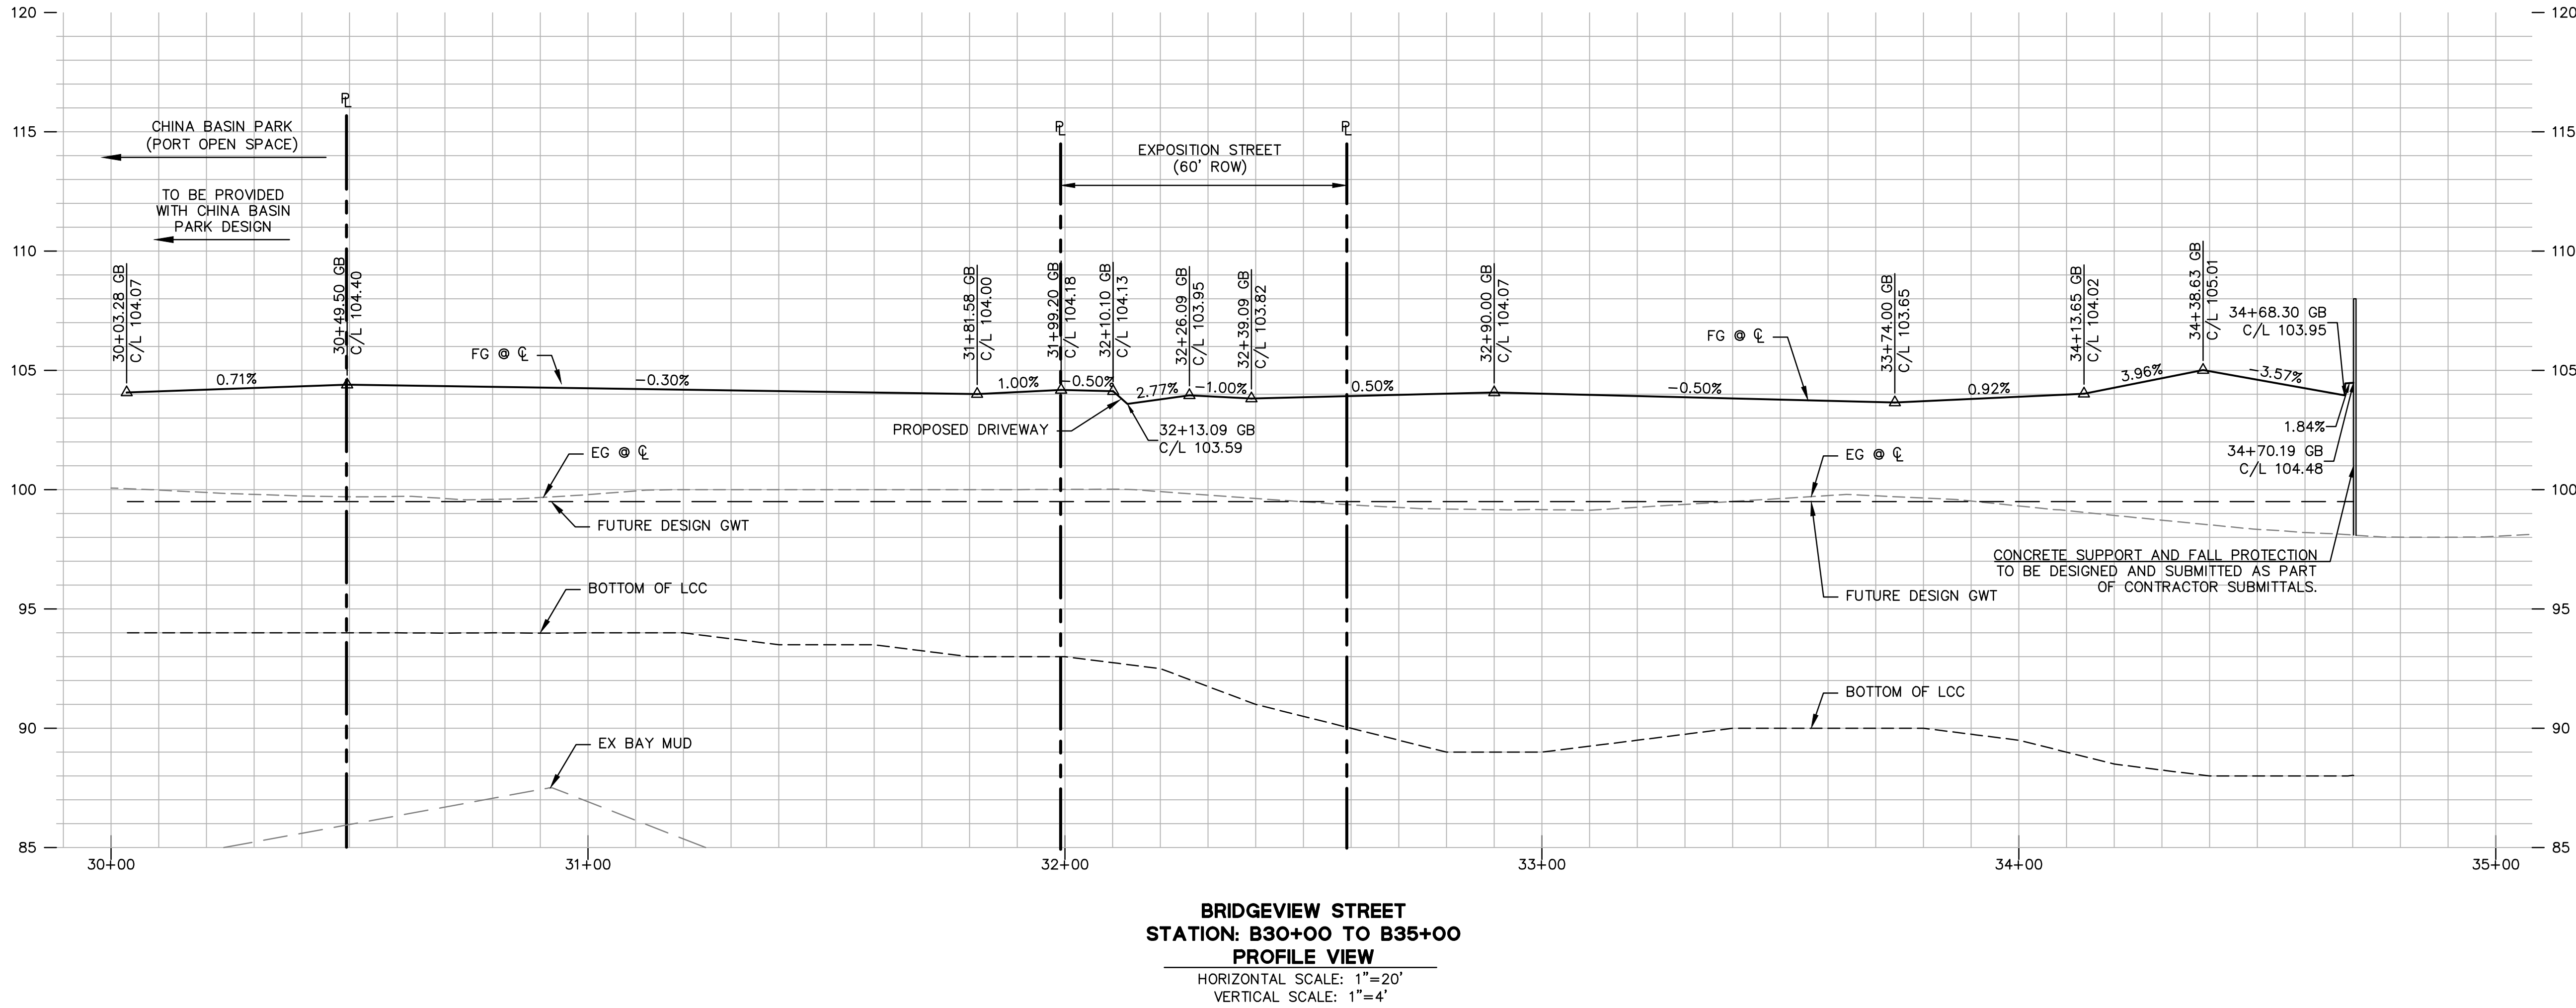

GRADING NOTES

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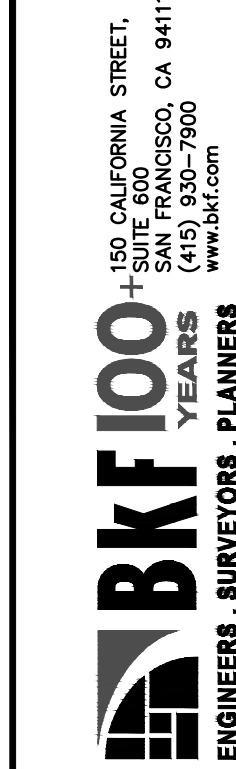


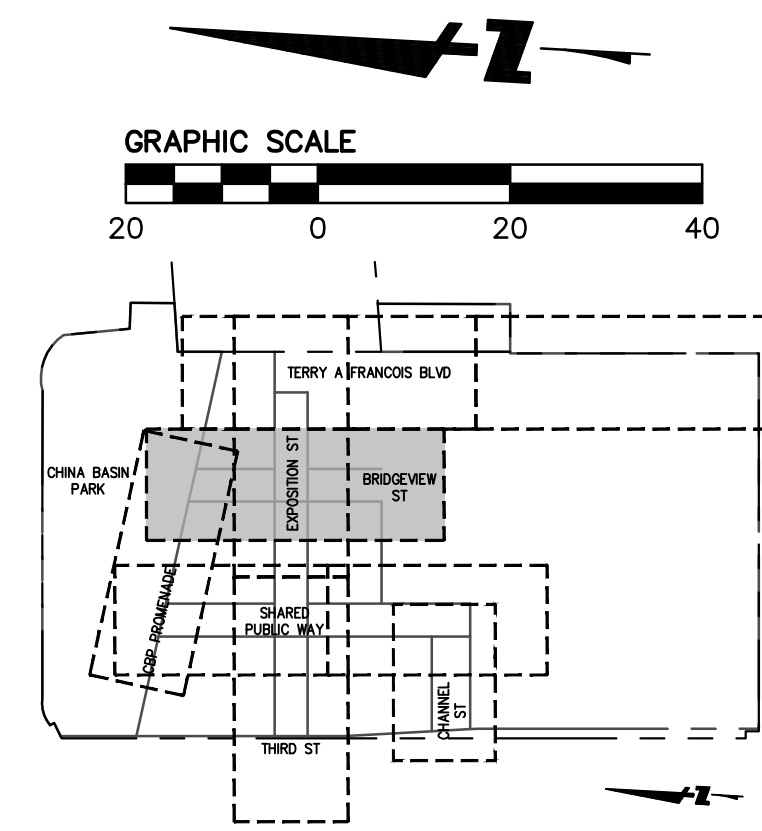**MISSION ROCK PHASE 1
STREET IMPROVEMENT PLANS
GRADING PLAN - BRIDGEVIEW STREET**

SAN FRANCISCO

SAN FRANCISCO COUNTY

CALIFORNIA



Revisions	
No.	Scale AS SHOWN
1	Design
2	Drawn
3	Approved
4	Job No 20080006

Drawing Number:
C6.05
60 OF 283

FIRST SUBMITTAL - NOT FOR CONSTRUCTION